

SHEET NOTES

- REFER TO SHEET FX001 FOR SYMBOLS AND ABBREVIATIONS.
- REMOVE EXISTING SPRINKLER SYSTEM BACK TO INCOMING FIRE SERVICE AS INDICATED.
- SPRINKLER SYSTEM LAYOUT HAS BEEN TRACED FROM EXISTING AS BUILT DRAWINGS WITH LIMITED FIELD VERIFICATION. FIRE PROTECTION CONTRACTOR SHALL VERIFY ALL DIMENSIONS AND THE EXISTING CONDITIONS OF SPRINKLERS AND SPRINKLER ASSOCIATED EQUIPMENT PRIOR TO COMMENCING WORK.
- DEMOLITION WORK WITHIN EACH PHASE SHALL NOT COMMENCE UNTIL NEW WORK SPRINKLER SYSTEM IS INSTALLED AND ACTIVATED IN THAT PHASE. REFER TO SHEET NOTE 5 ON SHEET FX102.
- COMPLY WITH CONSTRUCTION PHASING AND SEQUENCING NOTES ON SHEET G005.

KEYNOTES

- EXISTING SPRINKLER PIPING AND ASSOCIATED EQUIPMENT ABOVE THE OFFICE SPACE SHALL REMAIN. CAP EXISTING PIPE AT WORK BOUNDARY AS INDICATED. REMOVE SPRINKLER PIPING AND ASSOCIATED EQUIPMENT WITHIN WORK BOUNDARY. PROVIDE NEW SPRINKLER PIPING TO SERVE OFFICE SPACE AS PART OF PHASE 1 AND PHASE 3 WORK. OFFICE SPACE IS TO REMAIN OPERATIONAL AND SPRINKLER PROTECTION MAINTAINED DURING CONSTRUCTION. SEE SHEET NOTE 5 ON SHEET FX102.
- REMOVE SPRINKLER PIPING AND ASSOCIATED EQUIPMENT WITHIN BOUNDARY DURING PHASE 3. PROVIDE TEMPORARY CONNECTION TO KEEP SPRINKLERS IN PHASE 3 ACTIVE DURING PHASE 2 WORK.
- CAP MAIN AT THIS POINT AND REMOVE DOWNSTREAM PIPING AND SPRINKLERS DURING PHASE 2.
- MAINTAIN OFFICE SPRINKLER PROTECTION BY KEEPING THIS CONNECTION THROUGHOUT PHASE 1.

CAUTION: IF THIS PLAN IS A REDUCTION, GRAPHIC SCALE MUST BE USED

FULLY SPRINKLERED

WAREHOUSE RENOVATION & EXPANSION

Date

03/17/16

VA Project Number

512-530

Drawing Number

FJ101

OF XX

Scale

1/8" = 1'-0"

Building Number

360

Checked

CKC

Drawn

ACJ

Location

PERRY POINT, MD

SPRINKLER GROUND FLOOR DEMOLITION PLAN

1/8" = 1'-0"

Revisions:	Date
SCHEMATIC DESIGN (30%) SUBMISSION	03/25/15
DESIGN DEVELOPMENT (60%) SUBMISSION	09/11/15
CONSTRUCTION DOCUMENTS (90% SUBMISSION)	11/23/15
BID DOCUMENTS SUBMISSION	03/17/16

ARCHITECT / ENGINEERS / CONSULTANTS:	
OKKS Studios, Inc. 2 Wisconsin Circle / Suite 820 Chevy Chase, MD 20815-7003 Tel: (301) 718-0080 Fax: (301) 718-9520 www.okksstudios.com	Woods Peacock Engineering Consultants 5250 Cherokee Avenue, Suite 420 Alexandria, VA 22312-2052 Tel: (703) 658-4400 Fax: (703) 658-4404
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The Protection Engineering Group 2809 Boston Street, Suite 7 Baltimore, MD 21224 USA Tel: (443) 708-4096	



Approved:	Approved: Chief, Facilities and Engineering
	Approved: Associate Chief for Maintenance And Operations, Perry Point
	Approved: Engineering Projects Supervisor
	Approved: Infection Control Officer

Approved: Chief, Facilities and Engineering	Approved: Associate Chief for Maintenance And Operations, Perry Point
Approved: Engineering Projects Supervisor	Approved: Infection Control Officer

Drawing Title	SPRINKLER GROUND FLOOR DEMOLITION PLAN
Approved: Associate Director for Operations	Approved: Director, Medical Center


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1 SPRINKLER MEZZANINE DEMOLITION PLAN
1/8" = 1'-0"

0 4' 8' 16'

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Approved:

Approved: Chief, Facilities and Engineering
Approved: Associate Chief for Maintenance And Operations, Perry Point
Approved: Engineering Projects Supervisor
Approved: Infection Control Officer

Drawing Title
SPRINKLER MEZZANINE DEMOLITION PLAN
Approved: Associate Director for Operations
Approved: Director, Medical Center

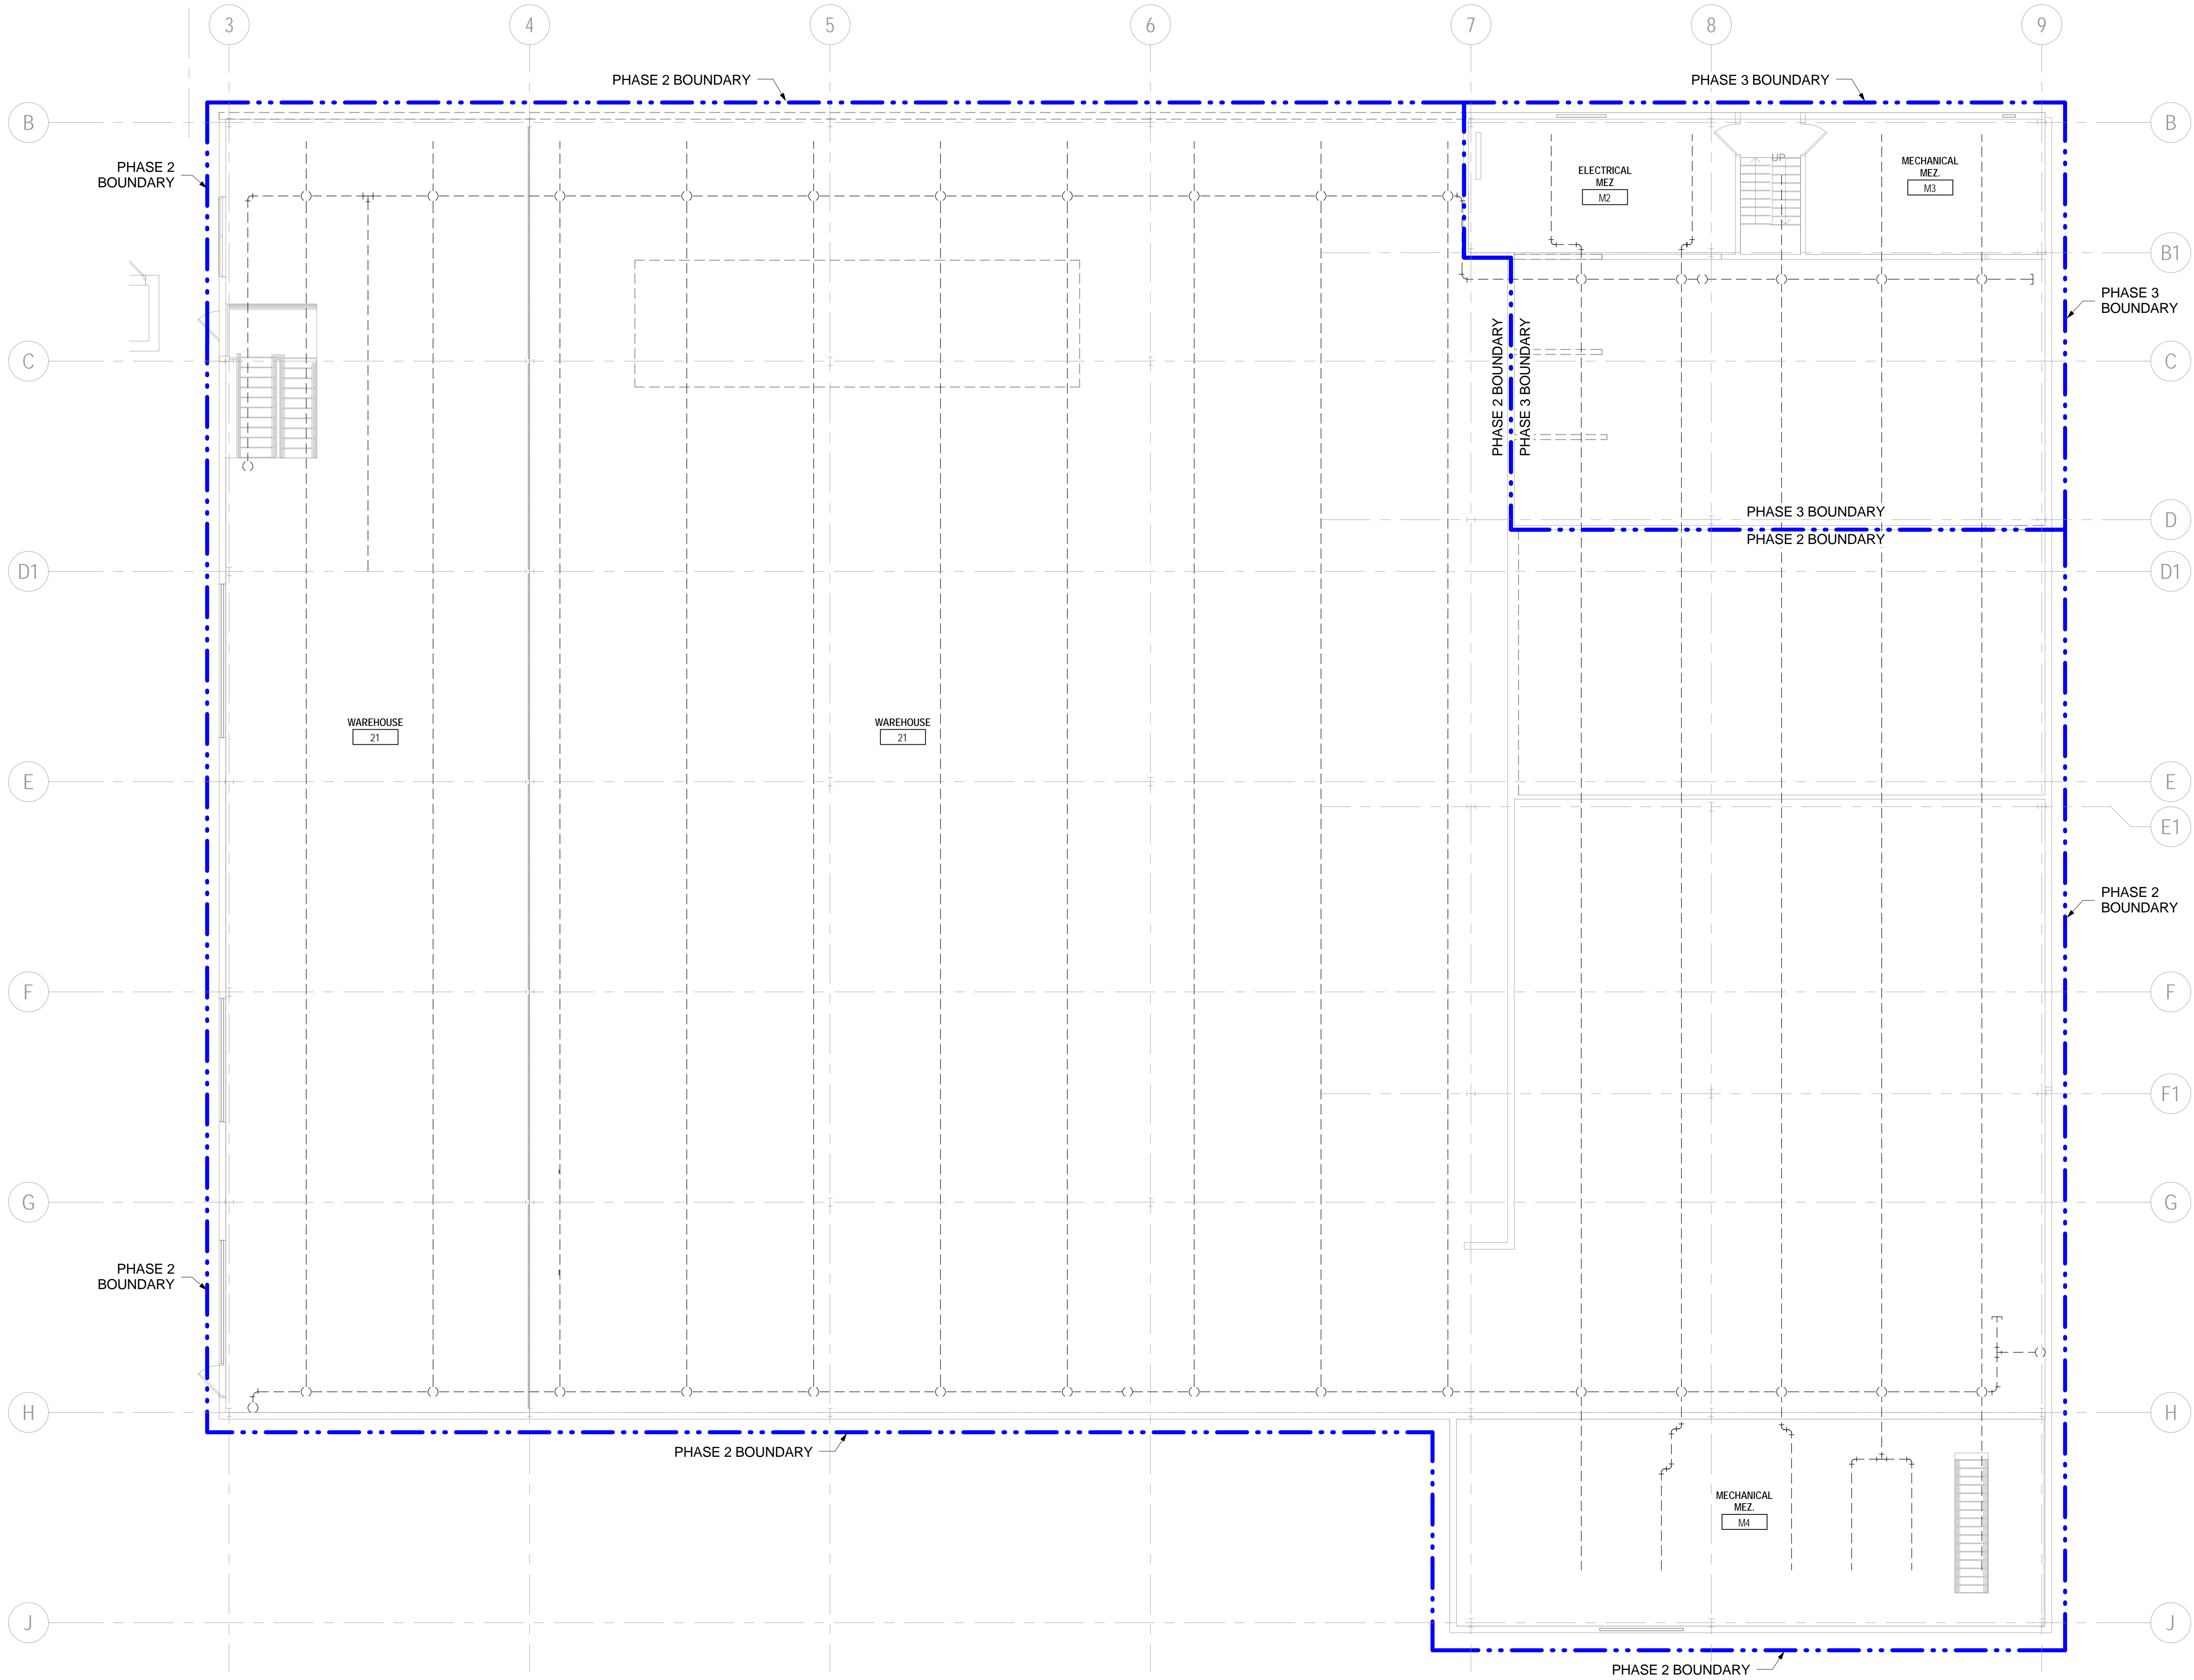FULLY SPRINKLERED

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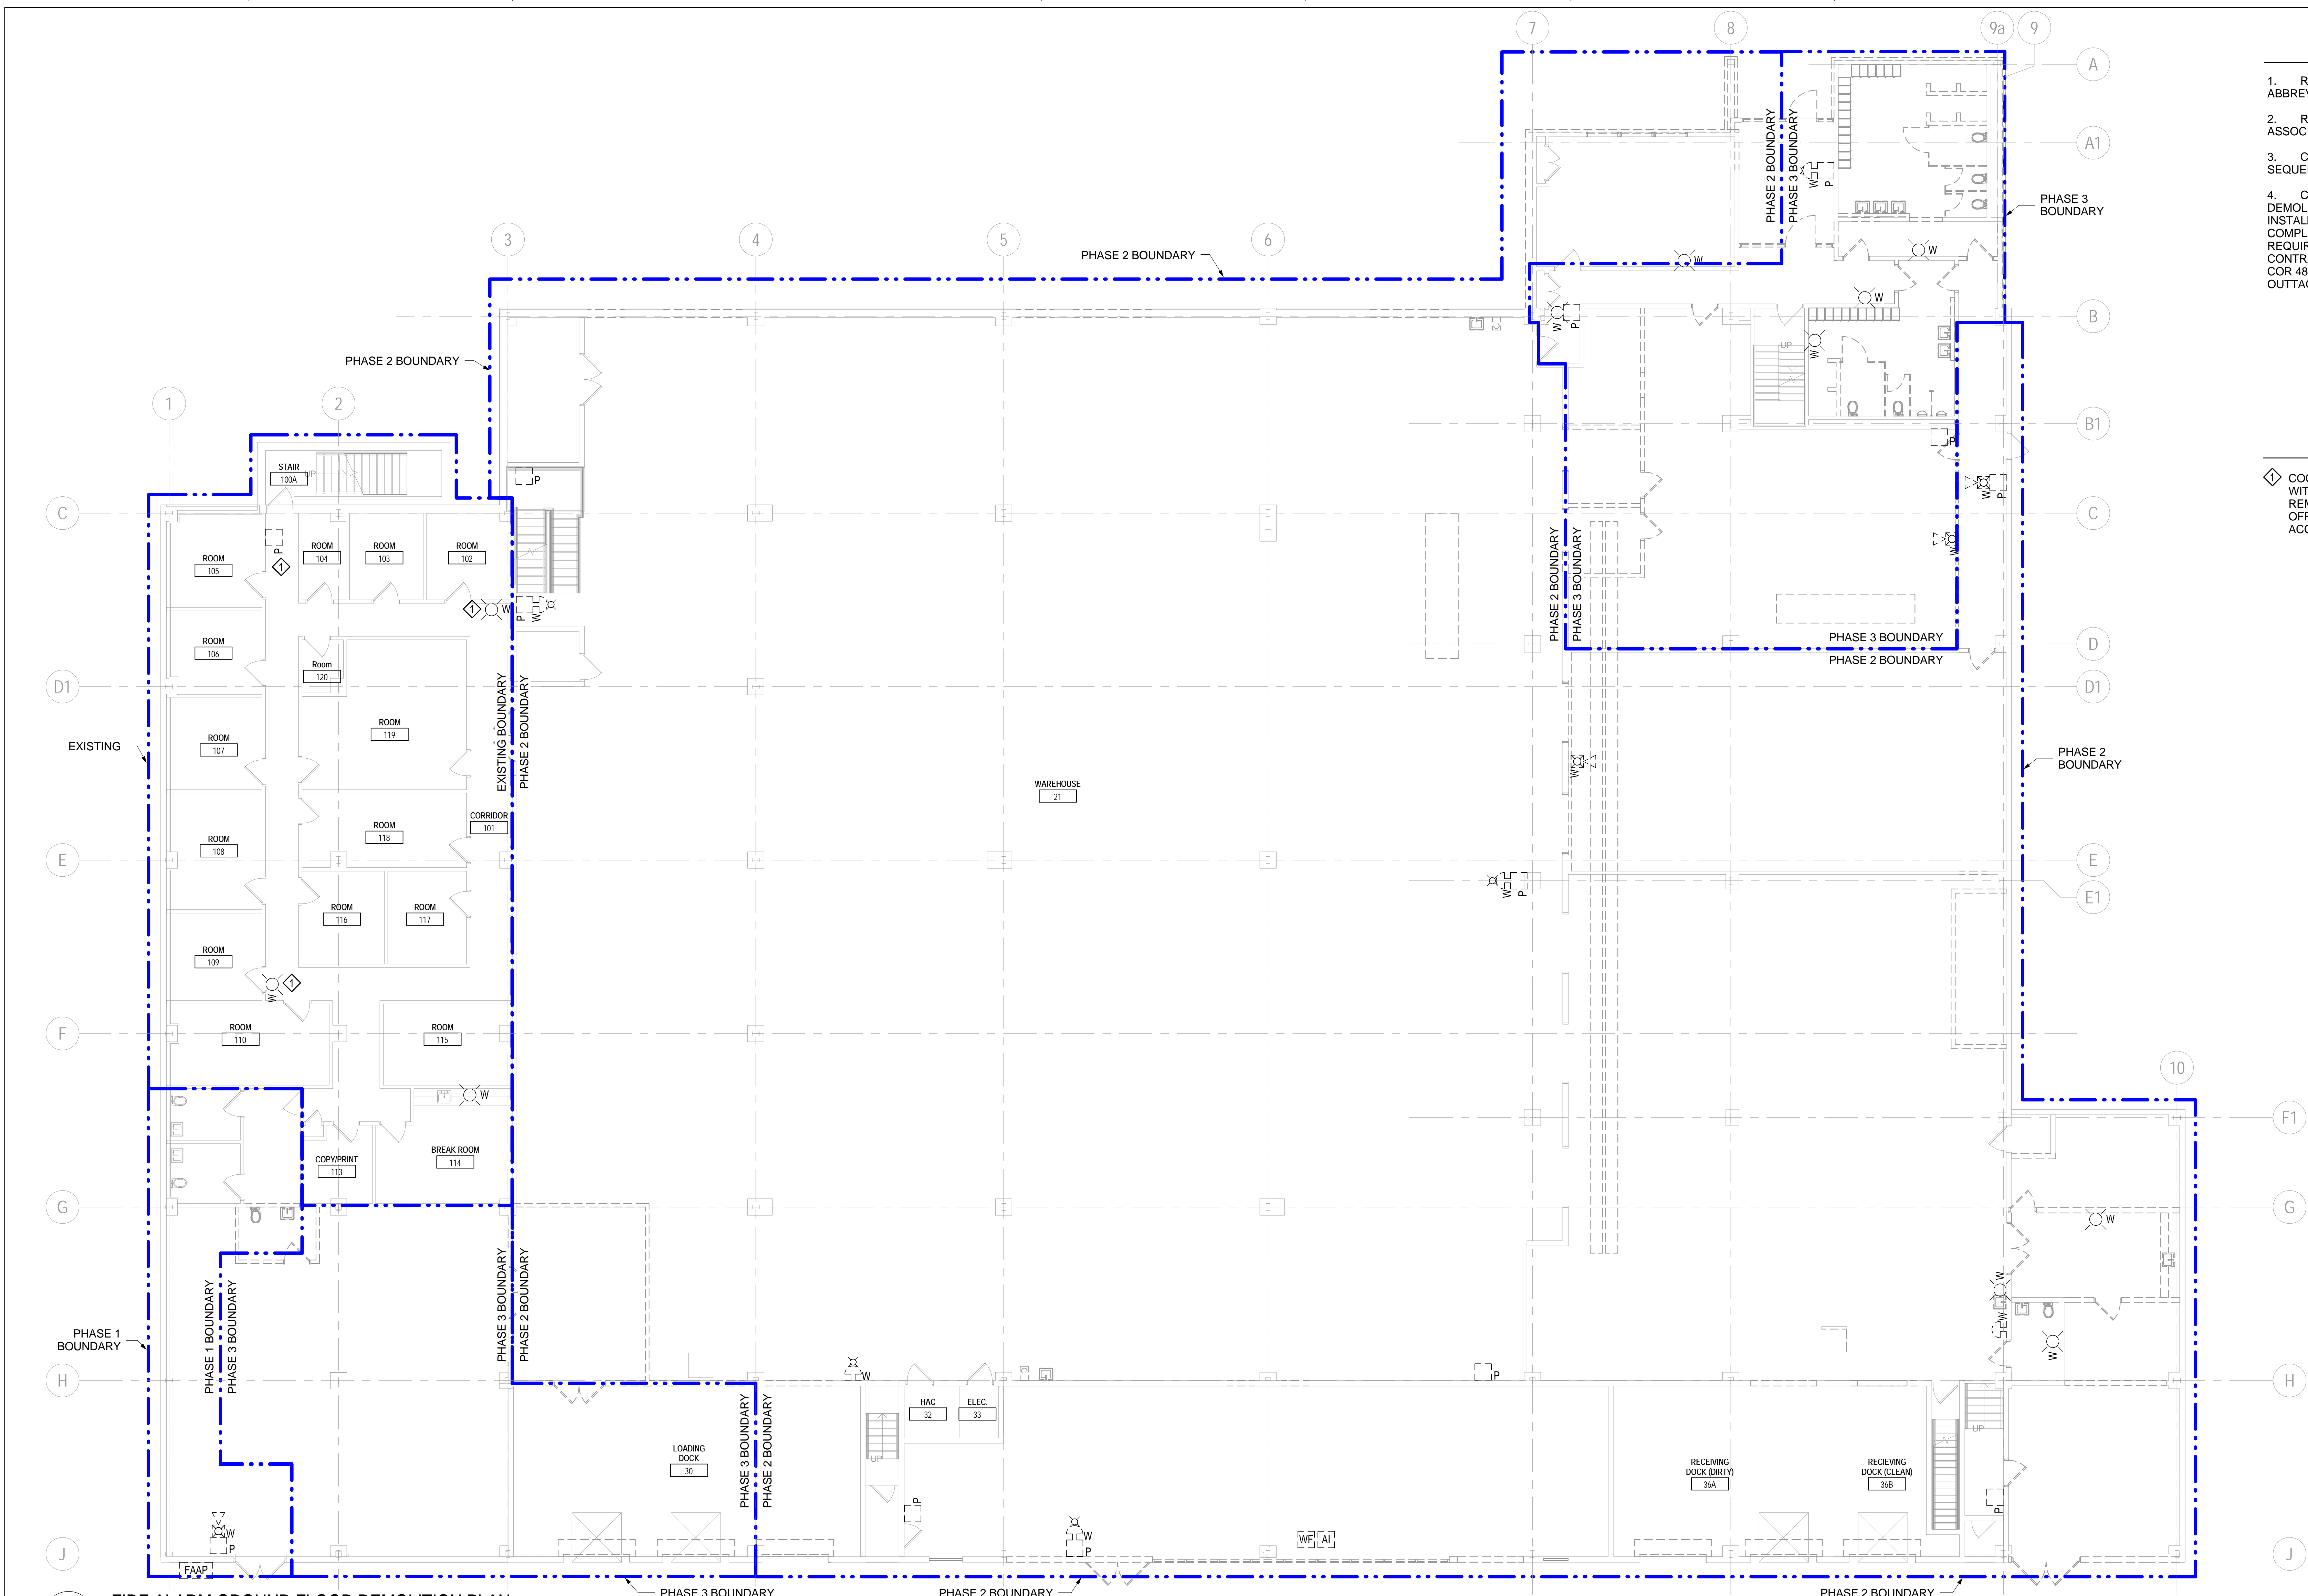


SHEET NOTES

1. REFER TO SHEET FA001 FOR SYMBOLS AND ABBREVIATIONS.
2. REMOVE EXISTING FIRE ALARM EQUIPMENT, ASSOCIATED CONDUIT AND RACEWAYS AS INDICATED.
3. COMPLY WITH CONSTRUCTION PHASING AND SEQUENCING NOTES ON SHEET G005.
4. CONTRACTOR SHALL NOT COMMENCE WITH DEMOLITION OF EXISTING FIRE ALARM SYSTEM UNTIL INSTALLATION AND ACCEPTANCE OF NEW SYSTEM IS COMPLETE. IF AN OUTAGE OF THE EXISTING SYSTEM IS REQUIRED PRIOR TO ACTIVATION OF THE NEXT SYSTEM, CONTRACTOR SHALL REQUEST PERMISSION FROM VA COR 48 HOURS PRIOR TO THE REQUESTED SYSTEM OUTAGE.

KEYNOTES

- ◇ COORDINATE REMOVAL OF FIRE ALARM EQUIPMENT WITH VA COTR. EQUIPMENT SHALL ONLY BE REMOVED AFTER NEW FIRE ALARM SYSTEM SERVING OFFICE SPACE IS INSTALLED, TESTED AND ACCEPTED.



1 FIRE ALARM GROUND FLOOR DEMOLITION PLAN

Revisions:	Date
SCHEMATIC DESIGN (30%) SUBMISSION	03/25/15
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Drawing Title	FIRE ALARM GROUND FLOOR DEMOLITION PLAN
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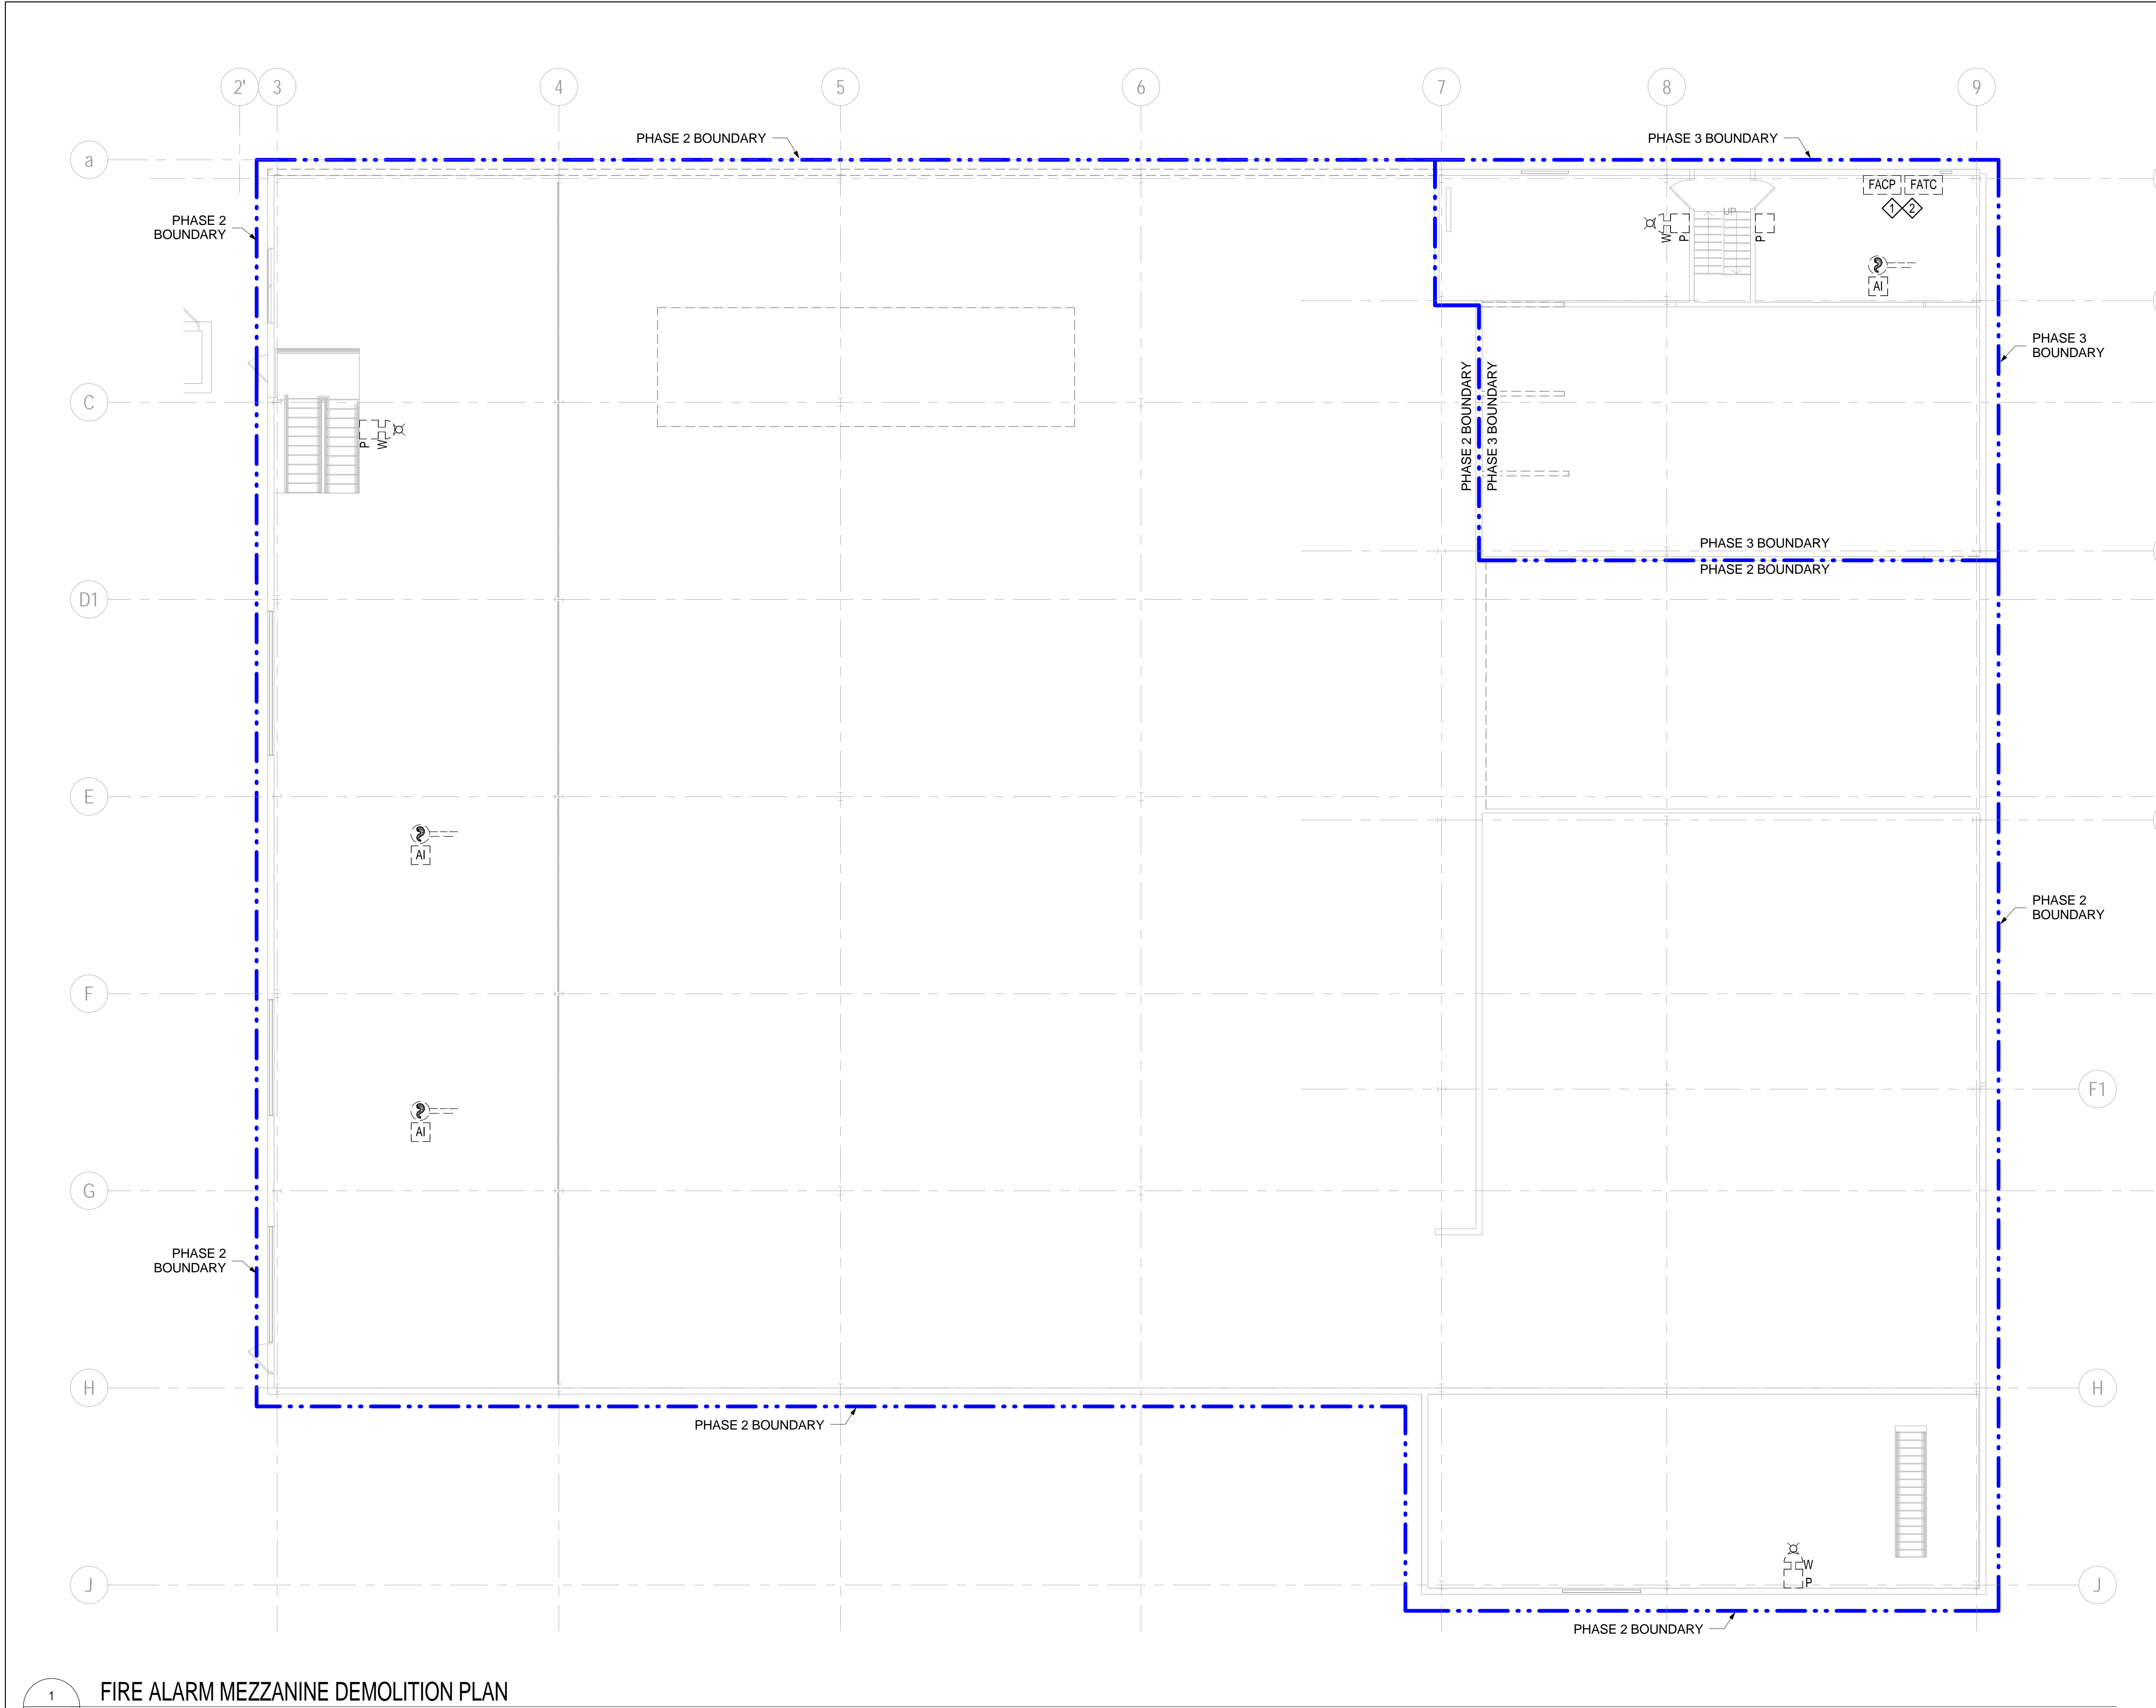
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DEPARTMENT OF VETERANS AFFAIRS

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5. REMOVE EQUIPMENT DURING PHASE 2, UNLESS NOTED OTHERWISE.

KEYNOTES

- ◇ EXISTING SIGCOM PANEL TO REMAIN.
- ◇ REMOVE EXISTING FACP AND FATC ONLY AFTER ALL NEW FIRE ALARM EQUIPMENT IS INSTALLED, TESTED AND APPROVED.



1 FIRE ALARM MEZZANINE DEMOLITION PLAN
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Stamp/Seal
Professional Certification I certify that these documents were prepared or approved by me, and that I am duly licensed professional engineer under the laws of the State of Maryland, License No. 41369, expiration date 01/05/2018.

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Approved: Associate Chief for Maintenance And Operations, Perry Point
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Approved: Infection Control Officer

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DEPARTMENT OF VETERANS AFFAIRS

3. THE TERM "PROVIDE" SHALL MEAN THE CONTRACTOR SHALL FURNISH, INSTALL, INSTALL AND CONNECT FOR COMPLETE AND OPERATIONAL SYSTEM.
4. THE TERM "REMOVE" SHALL MEAN THE CONTRACTOR SHALL DISCONNECT AND CLEAR FROM SITE.
5. THE SCOPE OF THIS PROJECT INCLUDES MODIFYING AND EXPANDING THE AUTOMATIC SPRINKLER SYSTEM THROUGHOUT THE WAREHOUSE 360 FACILITY AS INDICATED ON THE DRAWINGS AND AS DESCRIBED IN THE SPECIFICATIONS. THIS INCLUDES ALL PIPING, WATER FLOW ALARM SWITCHES, VALVE SUPERVISORY SWITCHES, CHECK VALVES, CONTROL VALVES, HANGERS, SPRINKLERS AND ALL ASSOCIATED EQUIPMENT. SPRINKLER DESIGN FOR WAREHOUSE 360 SHALL BE USED IN CONJUNCTION WITH NEW FIRE PUMP DESIGN, ALL SPRINKLER SYSTEM EQUIPMENT AND MATERIALS USED SHALL BE UNDERWRITERS LABORATORIES (UL) LISTED AND/OR FACTORY MUTUAL (FM) APPROVED.
6. ALL WORK AND INSTALLATION SHALL CONFORM TO THE APPLICABLE CODES AND STANDARDS INCLUDING:
 - NFPA 13: INSTALLATION OF SPRINKLER SYSTEMS (2013)
 - NFPA 20: STANDARD FOR THE INSTALLATION OF STATIONARY PUMPS FOR FIRE PROTECTION (2013)
 - NFPA 70: NATIONAL ELECTRIC CODE (2014)
 - NFPA 72: NATIONAL FIRE ALARM AND SIGNALING CODE (2013)
 - NFPA 101: LIFE SAFETY CODE (2015)
 - DEPARTMENT OF VETERANS AFFAIRS FIRE PROTECTION DESIGN MANUAL, SIXTH EDITION (SEPTEMBER 2011)
 - INTERNATIONAL BUILDING CODE (2015)
7. INFORMATION CONTAINED IN THESE DRAWINGS IS BASED ON EXISTING DOCUMENTS AND LIMITED FIELD MEASUREMENT VERIFICATION. THE INFORMATION CONTAINED HEREIN MAY REQUIRE ADJUSTMENTS AND/OR MODIFICATIONS TO CONFORM TO EXISTING CONDITIONS. IN ADDITION, THE CONTRACTOR SHALL NOTIFY THE CONTRACTING OFFICER IF ANY DISCREPANCY IN EXISTING CONDITION SHOULD PROHIBIT EXECUTION OF THE DESIGN INTENT OF THESE DRAWINGS.
8. COORDINATION WITH STRUCTURAL ELEMENTS AND OTHER TRADES IS THE RESPONSIBILITY OF THE CONTRACTOR. THE CONTRACTOR SHALL BE RESPONSIBLE FOR FIELD VERIFYING THE LAYOUT OF THE AUTOMATIC SPRINKLER SYSTEM PRIOR TO FABRICATION & INSTALLATION OF PIPE. INSTALLATION SHOP DRAWINGS AND MANUFACTURER'S DATA SHEETS SHALL BE SUBMITTED TO THE ENGINEER OF RECORD AND OWNER FOR APPROVAL BEFORE PURCHASE AND INSTALLATION. DEVIATIONS FROM CONSTRUCTION DOCUMENTS SHALL BE CLEARLY ANNOTATED AND SUBMITTED TO THE ENGINEER OF RECORD FOR APPROVAL. FINAL LAYOUT OF THE SYSTEMS SHALL BE COMPLETED BY THE CONTRACTOR AND COORDINATED WITH FIELD CONDITIONS.
9. OBTAIN ALL REQUIRED PERMITS AT NO ADDITIONAL COST TO THE OWNER.
10. ANY INFORMATION CONFLICTS BETWEEN THE SPECIFICATIONS AND DRAWINGS SHALL BE BROUGHT TO THE CONTRACTING OFFICER'S TECHNICAL REPRESENTATIVE'S ATTENTION. THE CONTRACTOR SHALL NOT PROCEED WITH ANY WORK EXCEPT AT THEIR OWN RISK UNTIL CLARIFICATIONS OF THE CONFLICTS ARE ISSUED TO THE CONTRACTOR BY THE CONTRACTING OFFICER'S TECHNICAL REPRESENTATIVE.
11. SPRINKLER SYSTEMS SHALL CONSIST OF WET PIPE TYPE SYSTEMS THROUGHOUT THE ENTIRE PROJECT AREA. THE TYPES OF OCCUPANCIES PRESENT IN THE PROJECT AREA AND THEIR NFPA 13 HAZARD CLASSIFICATIONS ARE AS INDICATED ON THE PLANS.
12. PIPE SIZES INDICATED HAVE BEEN DETERMINED BY HYDRAULIC CALCULATIONS BASED ON THE USE OF SCHEDULE 40/10 STEEL PIPE. SUBMIT HYDRAULIC CALCULATIONS FOR ALL SPRINKLER SYSTEMS. A SAFETY FACTOR SHALL BE INCLUDED BY CALCULATING THE DEMAND TO A POINT NO GREATER THAN 10% BELOW THE AVAILABLE WATER SUPPLY CURVE. OR, A 10% SAFETY FACTOR SHALL BE PROVIDED (SUBTRACT 10% FROM THE AVAILABLE WATER SUPPLY CURVE) FOR EACH SPRINKLER DEMAND INCLUDING THE REQUIRED HOSE STREAMS. ALL PIPE SIZES 2" 1/2" TO 8" SHALL BE ROLLED GROOVED AND JOINED WITH GROOVED FITTINGS. ALL PIPE SIZES UP TO AND INCLUDING 2" SHALL BE SCHEDULE 40 AND USE THREADED OR GROOVED FITTINGS.
13. THE STEEL PIPING SYSTEMS INCLUDING VALVES, PIPING, PIPE SLEEVES, HANGERS AND ACCESSORIES SHALL BE CLEANED TO REMOVE ALL DUST, DIRT AND LOOSE MILD SCALE. CONCEAL ALL SPRINKLER PIPING IN AREAS PROVIDED WITH SUSPENDED CEILINGS.
14. OBTAIN ALL NECESSARY PERMITS AND APPROVALS PRIOR TO CONDUCTING ANY WELDING AND CUTTING OPERATIONS.
15. AVOID ALL CONFLICTS WITH LIGHTING FIXTURES, DIFFUSERS, GRILLS, DUCTS, STRUCTURAL MEMBERS, PIPES AND OTHER OBSTRUCTIONS ENCOUNTERED.
16. ALL WALL AND FLOOR PENETRATIONS SHALL BE CORE-DRILLED. PROVIDE PIPE SLEEVES FOR ALL WALL AND FLOOR PENETRATIONS AS INDICATED IN SPECIFICATION 210517. ALL PENETRATIONS IN WALLS, CEILINGS AND FLOORS SHALL BE SEALED TO THE FULL THICKNESS OF THE PENETRATION WITH AN APPROVED THROUGH PENETRATION FIRESTOP SYSTEM OF EQUAL OR GREATER FIRE RESISTANCE AND AS INDICATED IN SPECIFICATION 078400. REFER TO ARCHITECTURAL DRAWINGS FOR FLOOR SLAB, WALL AND CEILING RATINGS.
17. ALL DAMAGE TO WALLS, CEILINGS, FLOORS, AND STRUCTURAL MEMBERS FROM PENETRATIONS, INSTALLATIONS OR OTHER ACTIONS OF THE CONTRACTOR SHALL BE PATCHED, REPAIRED AND PAINTED WITH NEW MATERIALS BY TO MATCH ADJACENT WORK, WHETHER SPECIFICALLY NOTED OR NOT.
18. DO NOT CUT, DRILL OR BURN ANY STRUCTURAL MEMBERS UNLESS PREVIOUSLY APPROVED BY THE STRUCTURAL ENGINEER. DO NOT CUT OR PATCH STRUCTURAL WORK IN A MANNER THAT WOULD RESULT IN A REDUCTION OF LOAD-CARRYING OR LOAD-DEFLECTION RATIO.
19. PROTECT ALL EQUIPMENT, FURNISHINGS, FIXTURES AND CONTENTS OF THE SPACE FROM DAMAGE, DUST, WATER AND DEBRIS ASSOCIATED WITH WORK. CONTRACTOR IS RESPONSIBLE FOR DAILY CLEAN UP, INCLUDING REMOVAL OF ALL TRASH, DEBRIS AND CONSTRUCTION MATERIALS ON A DAILY BASIS.
20. ALL NEW FIRE PROTECTION SYSTEM CONTROL VALVES SHALL BE EQUIPPED WITH APPROVED VALVE SUPERVISORY SWITCHES THAT ARE MONITORED BY THE FIRE ALARM CONTROL PANEL. REFER TO THE ELECTRICAL DRAWINGS FOR ELECTRICAL WORK AND ALARM WIRING.
21. MAINTAIN AT LEAST 6 FT 8 INCH HEAD ROOM CLEARANCE BETWEEN BOTTOM OF SPRINKLER PIPE AND ADJACENT FLOOR, INCLUDING STAIRWELLS AND OTHER AREAS OF EXPOSED PIPE.
22. SPRINKLERS INSTALLED IN PROXIMITY TO DUCTS OR OTHER OBSTRUCTIONS SHALL BE LOCATED TO MINIMIZE OBSTRUCTION TO DISCHARGE IN ACCORDANCE WITH NFPA 13.
23. ALL SPRINKLER PIPING SHALL BE INSTALLED SO THAT ALL PORTIONS OF THE SYSTEM CAN BE DRAINED BACK THROUGH THE DRAIN VALVE. THE CONTRACTOR SHALL FIELD LOCATE AUXILIARY DRAINS AND CONNECTIONS AS REQUIRED TO SUITABLE INTERIOR DRAINS OR THE BUILDING EXTERIOR PER NFPA 13. PIPING SHALL TERMINATED AT THE EXTERIOR OF THE BUILDING OUT TO A SPLASH BLOCK.
24. UNLESS OTHERWISE NOTED, QUICK RESPONSE RECESSED PENDENT SPRINKLERS WITH CHROME FINISH AND CHROME TWO-PIECE ESCUTCHEONS SHALL BE PROVIDED QUICK RESPONSE PENDENT OR UPRIGHT SPRINKLERS WITH BRASS FINISH SHALL BE PROVIDED IN AREAS WITHOUT CEILINGS. HORIZONTAL SIDEWALL SPRINKLERS SHALL BE QUICK RESPONSE WITH BRASS FINISH. SPRINKLERS SHALL BE INSTALLED IN THE CENTER OF THE CEILING TILE IN AREAS WITH A FINISHED SUSPENDED CEILING OR CENTER OF HALF TILE FOR 4'x2' CEILING GRIDS. PROVIDE SPARE SPRINKLERS OF EACH TYPE USED IN ACCORDANCE WITH THE REQUIREMENTS OF NFPA 13. GUARDS SHALL BE PROVIDED ON ALL SPRINKLER HEADS THAT ARE WITHIN 7 FEET OFF THE FINISHED FLOOR OR WHERE HEADS WILL BE SUBJECT TO MECHANICAL DAMAGE. CONCEALED SPRINKLERS SHALL NOT BE USED AND ALL SPRINKLERS INSTALLED ARE REQUIRED TO BE FM APPROVED AS QUICK RESPONSE EXCEPT FOR THOSE IDENTIFIED WITHIN THE VA FIRE PROTECTION DESIGN MANUAL.
25. SPRINKLER PROTECTION FOR AREAS CONTAINING RACK SPRINKLERS IS BASED ON THE STORAGE OF CLASS IV COMMODITIES ON RACKS WITHOUT SOLID SHELVES WITH A MAXIMUM CEILING HEIGHT OF 20 FEET AND A MAXIMUM STORAGE HEIGHT OF 30 FEET. THE STORAGE CONTENTS IS ANTICIPATED TO CONTAIN SOME PLASTICS, BUT UNDER THE LIMIT ALLOWED FOR CLASS IV COMMODITIES PER NFPA 13. STORAGE OF HIGHER HAZARDOUS CONTENT, OR STORAGE AT A HEIGHT GREATER THAN 20 FEET WILL REQUIRE DIFFERENT MEASURES TO COMPLY WITH NFPA 13.
26. CONTRACTOR SHALL PROVIDE MINIMUM 48 HOURS NOTICE TO THE CONTRACTING OFFICER'S TECHNICAL REPRESENTATIVE BEFORE ANY REQUESTED SPRINKLER SYSTEM OUTAGES.
27. SPRINKLER SYSTEM WORK SHALL BE COORDINATED WITH THE PHASE APPROACHED AS SHOWN ON DETAIL 1 AND ON SHEET G005.

WAREHOUSE 20:
PROVIDE WET-PIPE SPRINKLERS DESIGNED FOR DOUBLE ROW RACK STORAGE WITHOUT SOLID SHELVES; MAXIMUM STORAGE HEIGHT OF 20FT AND MAXIMUM CEILING HEIGHT OF 30 FT. PROVIDE K16.8, NOMINAL 165°F, CORROSION RESISTANT CMSA UPRIGHT SPRINKLERS. MAXIMUM SPACING; 100 SQ. FT. FOLLOW NFPA 13 TABLE 16.2.2.1. FOR DESIGN CRITERIA.

WAREHOUSE 21:
PROVIDE WET-PIPE SPRINKLERS DESIGNED FOR DOUBLE ROW RACK STORAGE WITHOUT SOLID SHELVES; MAXIMUM STORAGE HEIGHT OF 20FT AND MAXIMUM CEILING HEIGHT OF 30 FT. PROVIDE K16.8, NOMINAL 165°F, CORROSION RESISTANT CMSA UPRIGHT SPRINKLERS. MAXIMUM SPACING; 100 SQ. FT. FOLLOW NFPA 13 TABLE 16.2.2.1. FOR DESIGN CRITERIA.

WAREHOUSE 24:
ORDINARY HAZARD GROUP 2 (HIGH DENSITY STORAGE UNITS)

WAREHOUSE 25:
ORDINARY HAZARD GROUP 2 (HIGH DENSITY STORAGE UNITS)

WAREHOUSE 26:
PROVIDE WET-PIPE SPRINKLERS DESIGNED FOR DOUBLE ROW RACK STORAGE WITHOUT SOLID SHELVES; MAXIMUM STORAGE HEIGHT OF 20FT AND MAXIMUM CEILING HEIGHT OF 30 FT. PROVIDE K16.8, NOMINAL 165°F, CORROSION RESISTANT CMSA UPRIGHT SPRINKLERS. MAXIMUM SPACING; 100 SQ. FT. FOLLOW NFPA 13 TABLE 16.2.2.1. FOR DESIGN CRITERIA.

SECURE STORAGE 159:
PROVIDE WET-PIPE SPRINKLERS DESIGNED FOR SINGLE ROW RACK STORAGE WITHOUT SOLID SHELVES; MAXIMUM STORAGE HEIGHT OF 20FT AND MAXIMUM CEILING HEIGHT OF 30 FT. PROVIDE K16.8, NOMINAL 165°F, CORROSION RESISTANT CMSA UPRIGHT SPRINKLERS. MAXIMUM SPACING; 100 SQ. FT. FOLLOW NFPA 13 TABLE 16.2.2.1. FOR DESIGN CRITERIA.

UNIFORM AREA:
ORDINARY HAZARD GROUP 2

	NEW WORK LINE TYPE
	EXISTING LINE TYPE
	DEMOLITION LINE TYPE
	SPRINKLER ZONE BOUNDARY
	HYDRAULIC AREA BOUNDARY
	PHASE BOUNDARY
	PIPE CONTINUATION
	PIPE CAP
	90° ELBOW TURNED AWAY FROM VIEWER
	TEE TURNED AWAY FROM VIEWER
	SPRINKLER/STANDPIPE RISER
	O.S. &Y. CONTROL VALVE WITH TAMPER SWITCH
	BUTTERFLY CONTROL VALVE WITH TAMPER SWITCH
	DOUBLE CHECK BACKFLOW PREVENTER ASSEMBLY WITH TAMPER SWITCH
	TEST-DRAIN
	WATERFLOW SWITCH
	CHECK VALVE
	VALVE ON RISER - ZONE CONTROL ASSEMBLY
	VALVE ON RISER - DRAIN/TEST VALVE
	FIRE DEPARTMENT CONNECTION - WALL MOUNTED
	TEST HEADER - WALL MOUNTED
	ECCENTRIC REDUCER
	CONCENTRIC REDUCER
	PENDENT SPRINKLER
	UPRIGHT SPRINKLER
	K16.8; UPRIGHT SPRINKLER
	RECESSED PENDENT SPRINKLER
	HORIZONTAL SIDEWALL SPRINKLER
	HYDRAULIC NODE INDICATOR
	KEYNOTE INDICATOR

AF	ABOVE FINISHED FLOOR
AHJ	AUTHORITY HAVING JURISDICTION
ACC	ACOUSTICAL TILE CEILING
BM	BEAM
BOB	BOTTOM OF BEAM
CON	CONCRETE SLAB AND BEAMS
CONC	CONCRETE
CONF	CONFERENCE
COTR	CONTRACTING OFFICER'S TECHNICAL REPRESENTATIVE
CSA	CONCEALED SPLINE SUSPENDED ACOUSTICAL TILE
CSM	CONCEALED METAL SPLINE SUSPENDED ACOUSTICAL TILE
DEMO	DEMOLITION
DN	DOWN
ELEC	ELECTRICAL
EXIST	EXISTING
FDC	FIRE DEPARTMENT CONNECTION
FL	FLOOR
F.S.	FLOOR SWITCH
FT	FEET
GYP	GYPSEUM BOARD ON WOOD OR METAL JOISTS
IBC	INTERNATIONAL BUILDING CODE
IN	INCH
LAT	LAY-IN ACOUSTICAL TILE - SUSPENDED
LTH	LIGHT HAZARD
MAT	LAY-IN METAL TILE - SUSPENDED
MECH	MECHANICAL
NFPA	NATIONAL FIRE PROTECTION ASSOCIATION
NIC	NOT IN CONTRACT
NO	NUMBER
RM	ROOM
SERV	SERVICE
STL	STEEL DECK
TELE	TELEPHONE
UNO	UNLESS NOTED OTHERWISE
UON	UNLESS OTHERWISE NOTED
VA	DEPARTMENT OF VETERANS AFFAIRS
ZN	ZONE

ALL AREAS ARE TO BE CONSIDERED LIGHT HAZARD (0.10 GPM/SQ FT OVER 1500 SQ FT) UNLESS NOTED OTHERWISE. REDUCTION IN DESIGN AREA PER NFPA 13 IS PERMITTED.


OH1	ORDINARY HAZARD, GROUP 1 0.15 GPM/SQ FT OVER 1500 SQ FT
OH2	ORDINARY HAZARD, GROUP 2 0.20 GPM/SQ FT OVER 1500 SQ FT
SPH	SPECIAL HAZARD REFER TO DESIGN CRITERIA

DATE: 10/21/2014
TIME: 11:30 AM
PERFORMED BY: GHD, INC.

BEST HYDRANT
TATIC: 63 PSI
ESIDUAL: 57 PSI

LOW HYDRANT
LOW: 675 GPM

CONTRACTOR IS RESPONSIBLE FOR PERFORMING A WATER
SUPPLY FLOW TEST TO VERIFY THIS INFORMATION. COORDINATE
LOW TEST WITH VA COTR.

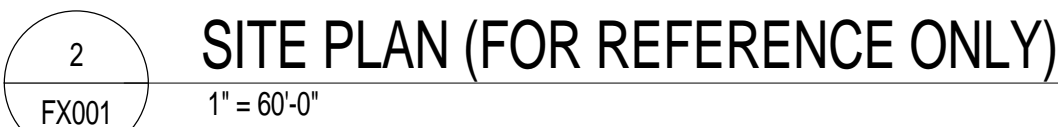

Additions:	Date
Revisions:	Date
SCHEMATIC DESIGN (30%) SUBMISSION	03/25/15
DESIGN DEVELOPMENT (60%) SUBMISSION	09/11/15
CONSTRUCTION DOCUMENTS (90% SUBMISSION)	11/23/15
BID DOCUMENTS SUBMISSION	03/17/16

ARCHITECT / ENGINEERS / CONSULTANTS:

<p>OKKS Studios, Inc. 2 Wisconsin Circle / Suite 820 Chevy Chase, MD 20815-7003 Tel: (301) 718-0080 Fax: (301) 718-9720 www.okksstudios.com</p>	<p>Woods Peacock Engineering Consultants 5250 Cherokee Avenue, Suite 420 Alexandria, VA 22312-2052 Tel: (703) 658-4400 Fax: (703) 658-4404</p>
<p>Henry Adams Consulting Engineers, LLC 600 Baltimore Avenue, 4th Floor Baltimore, MD 21204 Tel: (410) 296-6500 Fax: (410) 296-6501</p>	<p>Nobis Engineering, Inc. 20410 University Boulevard, Suite 130 Germantown, MD 20874 Tel: (301) 528-2010</p>
	<p>The Protection Engineering Group 2809 Boston Street, Suite 7 Baltimore, MD 21224 USA Tel: (443) 708-4096</p>



Approved:	

Approved: Chief, Facilities and Engineering
Approved: Associate Chief for Maintenance And Operations, Perry Point
Approved: Engineering Projects Supervisor
Approved: Infection Control Officer

Drawing Title
SPRINKLER REFERENCE SHEET
Approved: Associate Director for Operations
Approved: Director, Medical Center

Project Title			
WAREHOUSE RENOVATION & EXPANSION			
Scale	Building Number	Checked	Drawn
As indicated	360	CKC	ACJ
Location			
PERRY POINT, MD			

Date	03/17/16
VA Project Number	512-530
Drawing Number	FX0
	OF





- ◆ PROVIDE DRAIN CONNECTION FOR TRAPPED SPRINKLER PIPING. ROUTE DRAIN TO BUILDING EXTERIOR AND PROVIDE CONCRETE SPLASH BLOCK.
- ◆ PROVIDE CORROSION RESISTANT SPRINKLER HEADS IN AND NEAR THE SHOWERS. PREVENT PIPING, FITTINGS AND/OR THREADS FROM BEING EXPOSED TO WET ENVIRONMENT.
- ◆ PROVIDE NEW SPRINKLER WORK WITHIN PHASE 3 BOUNDARIES AND CONNECT TO MAIN PROVIDED DURING PHASE 2. SEE KEYNOTE 4 ON SHEET FX103.



Additions:		Date:	ARCHITECT / ENGINEERS / CONSULTANTS:		Stamp/Seal:		Approved:		Approved: Chief, Facilities and Engineering		Drawing Title		PROJECT SPRINKLERED		Date	
			OKKS Studios, Inc.		Woods Peacock Engineering Consultants						SPRINKLER BUILDING NORTH		WAREHOUSE RENOVATION		03/17/16	
			2 Wisconsin Circle / Suite 820		5250 Cherokee Avenue, Suite #20						GROUND FLOOR NEW WORK PLAN		& EXPANSION		VA Project Number	
			Chevy Chase, MD 20815-7003		Alexandria, VA 22312-2052										512-530	
			Tel: (301) 718-0080		Tel: (703) 698-4400											
			Fax: (301) 718-9530		Fax: (703) 698-4404											
			www.okkstudios.com													
Revisions:		Date:	Nobis Engineering, Inc.		The Protection Engineering Group						Approved: Associate Director for Operations		Scale		Drawing Number	
SCHEMATIC DESIGN (30%) SUBMISSION		03/25/15	20410 Century Boulevard, Suite 230		2809 Boston Street, Suite 7						Approved: Director, Medical Center		1/8" = 1'-0"		FX101	
DESIGN DEVELOPMENT (60%) SUBMISSION		09/11/15	Germanstown, MD 20874		Baltimore, MD 21224 USA								Building Number		OF XX	
CONSTRUCTION DOCUMENTS (90% SUBMISSION)		11/23/15	Tel: (301) 528-2010		Tel: (+43) 708-4096								360			
BID DOCUMENTS SUBMISSION		03/17/16	600 Baltimore Avenue, 4th Floor										Checked			
			Baltimore, MD 21204										CKC			
			Tel: (410) 296-6500										Drawn			
			Fax: (410) 296-6501										ACJ			


DEPARTMENT OF
VETERANS AFFAIRS

SHEET NOTES

1. REFER TO SHEET FX001 FOR SYMBOLS AND ABBREVIATIONS.
2. PROVIDE NEW SPRINKLER PROTECTION INCLUDING SPRINKLERS, PIPING, HANGERS AND ASSOCIATED EQUIPMENT THROUGHOUT BUILDING 360 IN ACCORDANCE WITH NFPA 13. PROVIDE SPRINKLER PROTECTION FOR THESE AREAS PER THE HAZARD CLASSIFICATION, DESIGN CRITERIA AND ZONING AS IDENTIFIED.
3. SPRINKLER CROSS MAIN AND BRANCHLINES ARE SHOWN FOR INFORMATION PURPOSES ONLY. CONTRACTOR SHALL PROVIDE THEIR OWN SPRINKLER PIPING CONFIGURATION THAT MEETS ALL HYDRAULIC CALCULATION REQUIREMENTS.
4. COMPLY WITH CONSTRUCTION PHASING AND SEQUENCING NOTES ON SHEET G005.
5. NEW SPRINKLER WORK FOR EACH PHASE SHALL BE INSTALLED AND ACTIVATED PRIOR TO COMMENCING DEMOLITION WORK IN THAT PHASE. AS NEW WORK WITHIN EACH PHASE IS COMPLETED, USE THE FOLLOWING PROCEDURE TO CONNECT NEW SPRINKLER SYSTEM:
 1. PROVIDE FIRE WATCH FOR BUILDING 360 FOR 30 MINUTES PRIOR TO COMMENCING WORK AND FOR THE ENTIRETY OF THE BELOW PROCEDURE.
 2. PROVIDE FORMAL NOTIFICATION TO THE VA COR 48 HOURS PRIOR TO THE REQUESTED SYSTEM SHUTDOWN.
 3. DISABLE BUILDING 360 SPRINKLER SYSTEM AT THE BUILDING CONTROL VALVE.
 4. COMPLETELY DRAIN SPRINKLER SYSTEM.
 5. DISCONNECT EXISTING SPRINKLER EQUIPMENT AS NEEDED AT POINT OF CONNECTION FOR WORK IN THE CURRENT PHASE.
 6. ATTACH NEW SPRINKLER WORK AT POINT OF CONNECTION FOR THE CURRENT PHASE.
 7. HYDROSTATICALLY TEST SPRINKLER ZONE IN ACCORDANCE WITH NFPA 13. THE SYSTEM SHALL NOT BE ENABLED UNTIL HYDROSTATIC TEST HAS BEEN PASSED.
 8. ENABLE EXISTING SPRINKLER SYSTEM AT THE CONTROL VALVE.
 9. FIRE WATCH SHALL CONTINUE 30 MINUTE AFTER SYSTEM HAS BEEN ENABLED.

KEYNOTES

- PHASE 1**
- 1. CONNECT NEW SPRINKLER WORK WITHIN PHASE 1 BOUNDARIES TO EXISTING BRANCHLINE CURRENTLY SERVING THE OFFICE SPACE. SEE SHEET NOTE 5 FOR PROCEDURE.
- PHASE 2**
- 1. PROVIDE INSPECTOR'S TEST CONNECTION FOR TRAPPED SPRINKLER PIPING. ROUTE DRAIN TO BUILDING EXTERIOR AND PROVIDE CONCRETE SPLASH BLOCK.
 - 2. PROVIDE SPRINKLER PROTECTION UNDER MEZZANINE FROM ZONE-2 SPRINKLER SYSTEM. REUSE EXISTING PENETRATIONS FOR NEW RISERS.
 - 3. PROVIDE FIRE PUMP AND NEW ZONE CONTROL ASSEMBLIES DURING PHASE 2. PROVIDE AND INSTALL ALL EQUIPMENT PRIOR TO COMMENCING PROCEDURE GIVEN IN SHEET NOTE 5 TO MINIMIZE OUTTAGE TIME.
- PHASE 3**
- 1. PROVIDE NEW SPRINKLER WORK WITHIN PHASE 3 BOUNDARIES AND CONNECT TO MAIN PROVIDED DURING PHASE 2. SEE KEYNOTE 4 ON SHEET FX103.

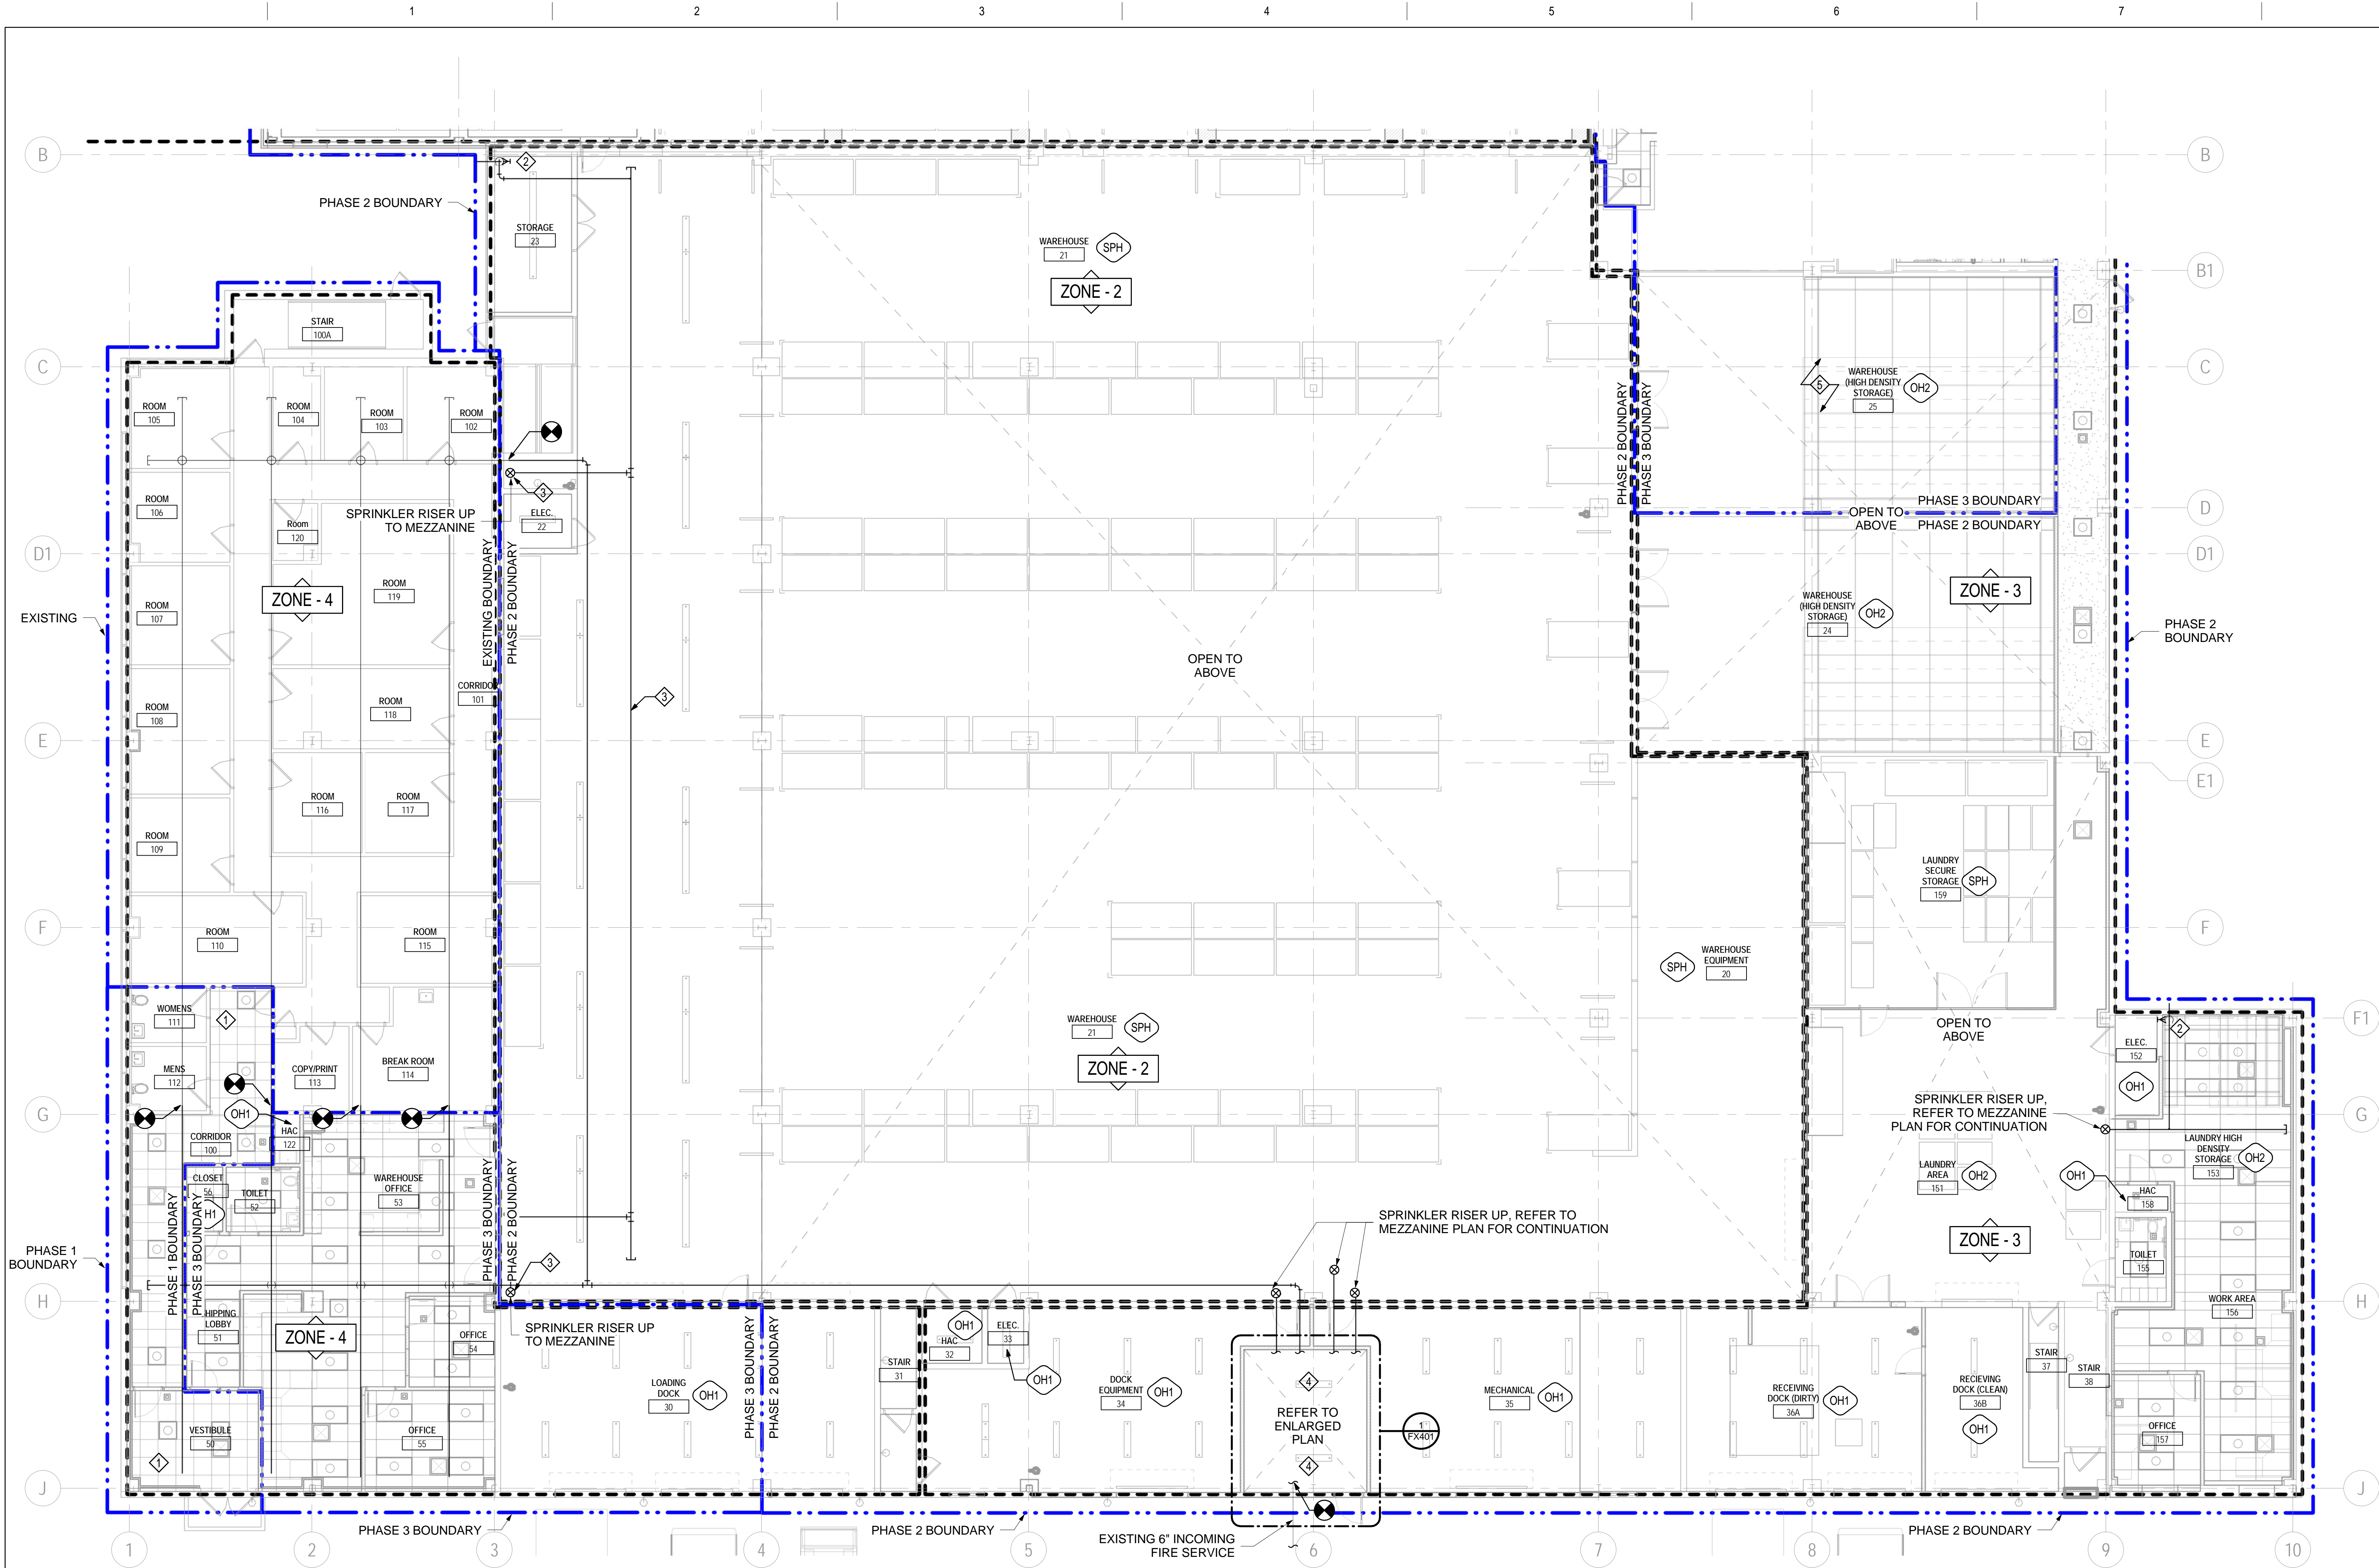

SPRINKLER BUILDING SOUTH GROUND FLOOR NEW WORK PLAN

1/8" = 1'-0"

0 4' 8' 16'

CAUTION: IF THIS PLAN IS A REDUCTION, GRAPHIC SCALE MUST BE USED

Additions:	Date
Revisions:	Date
SCHEMATIC DESIGN (30%) SUBMISSION	03/25/15
DESIGN DEVELOPMENT (60%) SUBMISSION	09/11/15
CONSTRUCTION DOCUMENTS (90% SUBMISSION)	11/23/15
BID DOCUMENTS SUBMISSION	03/17/16

ARCHITECT / ENGINEERS / CONSULTANTS:		
OKKS Studios, Inc. 2 Wisconsin Circle / Suite 820 Chevy Chase, MD 20815-7003 Tel: (301) 718-0080 Fax: (301) 718-9520 www.okksstudios.com	Woods Peacock Engineering Consultants 5250 Cherokee Avenue, Suite 420 Alexandria, VA 22312-2052 Tel: (703) 658-4400 Fax: (703) 658-4404	Nobis Engineering, Inc. 20410 Century Boulevard, Suite 230 Germantown, MD 20874 Tel: (301) 528-2010
Henry Adams Consulting Engineers, LLC 600 Baltimore Avenue, 4th Floor Baltimore, MD 21204 Tel: (410) 296-6500 Fax: (410) 296-6501	The Protection Engineering Group 2809 Boston Street, Suite 7 Baltimore, MD 21224 USA Tel: (443) 708-4096	Professional Certification I certify that these documents were prepared or approved by me, and that I am duly licensed professional engineer under the laws of the State of Maryland, License No. 41369, expiration date 01/05/2018.



Approved:

Approved: Chief, Facilities and Engineering
Approved: Associate Chief for Maintenance And Operations, Perry Point
Approved: Engineering Projects Supervisor
Approved: Infection Control Officer

Drawing Title
SPRINKLER BUILDING SOUTH GROUND FLOOR NEW WORK PLAN
Approved: Associate Director for Operations
Approved: Director, Medical Center

FULLY SPRINKLERED

Project Title
WAREHOUSE RENOVATION & EXPANSION
Scale
1/8" = 1'-0"
Building Number
360
Checked
CKC
Drawn
ACJ
Location
PERRY POINT, MD

Date
03/17/16
VA Project Number
512-530
Drawing Number
FX102
OF XX



SHEET NOTES

1. REFER TO SHEET FX001 FOR SYMBOLS AND ABBREVIATIONS.
2. PROVIDE NEW SPRINKLER PROTECTION INCLUDING SPRINKLERS, PIPING, HANGERS AND ASSOCIATED EQUIPMENT THROUGHOUT BUILDING 360 IN ACCORDANCE WITH NFPA 13. PROVIDE SPRINKLER PROTECTION FOR THESE AREAS PER THE HAZARD CLASSIFICATION, DESIGN CRITERIA AND ZONING AS IDENTIFIED.
3. SPRINKLER CROSS MAIN AND BRANCHLINES ARE SHOWN FOR INFORMATION PURPOSES ONLY. CONTRACTOR SHALL PROVIDE THEIR OWN SPRINKLER PIPING CONFIGURATION THAT MEETS ALL HYDRAULIC CALCULATION REQUIREMENTS.
4. COMPLY WITH CONSTRUCTION PHASING AND SEQUENCING NOTES ON SHEET G005.
5. NEW SPRINKLER WORK FOR EACH PHASE SHALL BE INSTALLED AND ACTIVATED PRIOR TO COMMENCING DEMOLITION WORK IN THAT PHASE. REFER TO SHEET NOTE 5 ON FX102.

KEYNOTES

- 1 REFER TO GROUND FLOOR PLAN FOR SPRINKLER CRITERIA FOR ASSOCIATED ROOM.
- 2 CONTRACTOR SHALL PROVIDE SPRINKLERS UNDERNEATH MECHANICAL DUCTWORK PER NFPA 13 REQUIREMENTS.
- 3 PROVIDE SPRINKLER PROTECTION UNDER MEZZANINE FROM ZONE-2 SPRINKLER SYSTEM. REUSE EXISTING PENETRATIONS FOR NEW RISERS.
- 4 DURING PHASE 2 WORK, PROVIDE NEW MAIN TO CONNECT TO PIPING SERVING PHASE 3 AREAS PRIOR TO DEMOLITION OF EXISTING SYSTEM. DURING CONNECTION OF PHASE 2 NEW WORK, DISCONNECT EXISTING DROPS SERVING PHASE 3 AREAS AND CONNECT TO NEW MAIN.

0 4' 8' 16'

CAUTION: IF THIS PLAN IS A REDUCTION, GRAPHIC SCALE MUST BE USED

FULLY SPRINKLERED

WAREHOUSE RENOVATION & EXPANSION

Date 03/17/16

VA Project Number 512-530

Drawing Number

FX103

OF XX

Scale

1/8" = 1'-0"

Building Number

360

Checked

CKC

Drawn

ACJ

Location

PERRY POINT, MD

SPRINKLER MEZZANINE NEW WORK PLAN

Approved: Associate Director for Operations

Approved: Director, Medical Center

Approved: Chief, Facilities and Engineering


Approved: Associate Chief for Maintenance And Operations, Perry Point

Approved: Engineering Projects Supervisor

Approved: Infection Control Officer

Approved:

Stamp/Seal

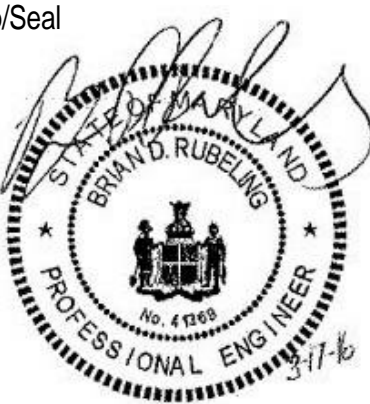

Professional Certification
I certify that these documents were prepared or approved by me, and that I am duly licensed professional engineer under the laws of the State of Maryland, License No. 41369, expiration date 01/05/2018.

ARCHITECT / ENGINEERS / CONSULTANTS:

OKKS Studios, Inc.
2 Wisconsin Circle / Suite 820
Chevy Chase, MD 20815-7003
Tel: (301) 718-0080
Fax: (301) 718-9520
www.okksstudios.com

Woods Peacock Engineering Consultants
5250 Cherokee Avenue, Suite 420
Alexandria, VA 22312-2052
Tel: (703) 658-4400
Fax: (703) 658-4404

Nobis Engineering, Inc.
20410 Century Boulevard, Suite 230
Germantown, MD 20874
Tel: (301) 528 2010

Henry Adams Consulting Engineers, LLC
600 Baltimore Avenue, 4th Floor
Baltimore, MD 21204
Tel: (410) 296-6500
Fax: (410) 296-6501

The Protection Engineering Group
2809 Boston Street, Suite 7
Baltimore, MD 21224 USA
Tel: (443) 708-4096

1 SPRINKLER MEZZANINE NEW WORK PLAN

FX103 1/8" = 1'-0"


Additions:	Date
Revisions:	Date
SCHEMATIC DESIGN (30%) SUBMISSION	03/25/15
DESIGN DEVELOPMENT (60%) SUBMISSION	09/11/15
CONSTRUCTION DOCUMENTS (90% SUBMISSION)	11/23/15
BID DOCUMENTS SUBMISSION	03/17/16

SHEET NOTES


1. ALL ELECTRICAL WIRING TO BE PROVIDED BY ELECTRICAL CONTRACTOR.
2. THIS DRAWING IS INTENT FOR USE AS A SCHEMATIC PIPING PLAN TO ILLUSTRATE CORRECT PLACEMENT, AND RELATIVE POSITION OF EQUIPMENT. ACTUAL ON SITE PIPING MAY VARY AFTER COORDINATION WITH ARCHITECTURAL, STRUCTURAL, AND MECHAINCAL FEATURES. ARRANGEMENT OF PIPING AND FITTINGS SHALL CONFORM TO NFPA-20-2013 REQUIREMENTS.
3. ENSURE THAT THE FIRE PUMP SUCTION PIPING IS INSTALLED IN ACCORDANCE WITH NFPA 20. ENSURE THAT ANY ELBOWS WITH CENTERLINES PARALLEL TO THE PUMP SHAFT ARE LOCATED AT A DISTANCE OF AT LEAST 10 TIMES THE SUCTION PIPE DIAMETER AWAY FROM THE PUMP SUCTION.
4. ROUTE ALL DRAIN PIPING WITHIN THE FIRE PUMP ROOM TO THE BUILDING EXTERIOR OR NEAREST FLOOR DRAIN.

FIRE PUMP LEGEND

- | | | | |
|----|--|----|---|
| 1 | EXISTING UNDERGROUND 6" INCOMING FIRE SERVICE | 22 | (6) 2 1/2" DIAMETER OUTLET HOSE VALVE WALL MOUNTED TEST HEADER |
| 2 | 8" FLANGED DOUBLE CHECK BACKFLOW PREVENTER WITH O.S.&Y. VALVES | 23 | SPARE SPRINKLER CABINET |
| 3 | 8" GROOVED 90° ELBOW | 24 | FIRE PUMP CONTROLLER WITH EMERGENCY POWER CAPABILITY |
| 4 | 8" GROOVED TEE | 25 | JOCKEY PUMP CONTROLLER |
| 5 | 8" FLANGED O.S.&Y. VALVE WITH SUPERVISORY SWITCH - SUPERVISED OPEN | 26 | ELECTRIC JOCKEY PUMP, 3/4 HP, 480V |
| 6 | 8"x6" FLANGES ECCENTRIC REDUCER | 27 | CONCRETE JOCKEY PUMP PAD |
| 7 | HORIZONTAL SPLIT CASE ELECTRIC MOTOR DRIVEN 1250 GPM @ 60 PSI FIRE PUMP | 28 | 1 1/4" WELDED THREADED OUTLET |
| 8 | ELECTRIC FIRE PUMP MOTOR - XX HP, XXXV | 29 | 1 1/4" THREADED INDICATING TYPE VALVE WITH SUPERVISORY SWITCH - SUPERVISED OPEN |
| 9 | FIRE PUMP STEEL DRIP RIM BASE | 30 | 1 1/4" THREADED 90° ELBOW |
| 10 | CONCRETE FIRE PUMP PAD, SEE DETAIL 7 ON SHEET FX501 | 31 | 1 1/4" THREADED SWING CHECK VALVE |
| 11 | PUMP SUPPLY PRESSURE GAUGE 0-250 PSI WITH 1/4" THREADED PETCOCK VALVE | 32 | 1 1/4" THREADED Y STRAINER |
| 12 | AUTOMATIC AIR RELIEF VALVE (DO NOT PIPE DISCHARGE TO DRAIN) | 33 | 1 1/4"x 1 1/4"x 1/2" THREADED TEE |
| 13 | PUMP DISCHARGE PRESSURE GAUGE 0-250 PSI WITH 1/4" THREADED PETCOCK VALVE | 34 | 1/2" THREADED BRASS ELBOW |
| 14 | 6"x8" FLANGED CONCENTRIC INCREASER | 35 | 1/2" THREADED BRASS SWING CHECK VALVE |
| 15 | 8" FLANGED CHECK VALVE | 36 | 8" GROOVED CAP |
| 16 | 8" GROOVED BUTTERFLY VALVE - SUPERVISED OPEN | 37 | 6" WELDED OUTLET |
| 17 | 8" GROOVED CHECK VALVE | 38 | 6" GROOVED BUTTERFLY VALVE WITH SUPERVISORY SWITCH - SUPERVISED OPEN |
| 18 | 8" GROOVED BUTTERFLY VALVE -SUPVISED CLOSED | 39 | 6" GROOVED RISER CHECK VALVE ASSEMBLY |
| 19 | 6" GROOVED 90° ELBOW | 40 | 6" WATERFLOW SWITCH |
| 20 | 6" GROOVED CHECK VALVE | 41 | PRESSURE RELIEF / TEST-DRAIN VALVE |
| 21 | 2 1/2"x 2 1/2"x 6" FIRE DEPARTMENT CONNECTION | 42 | 2" THREADED 90° ELBOW |
| | | 43 | 2" THREADED TEE |
| | | 44 | 2" DRAIN ROUTED TO EXTERIOR |

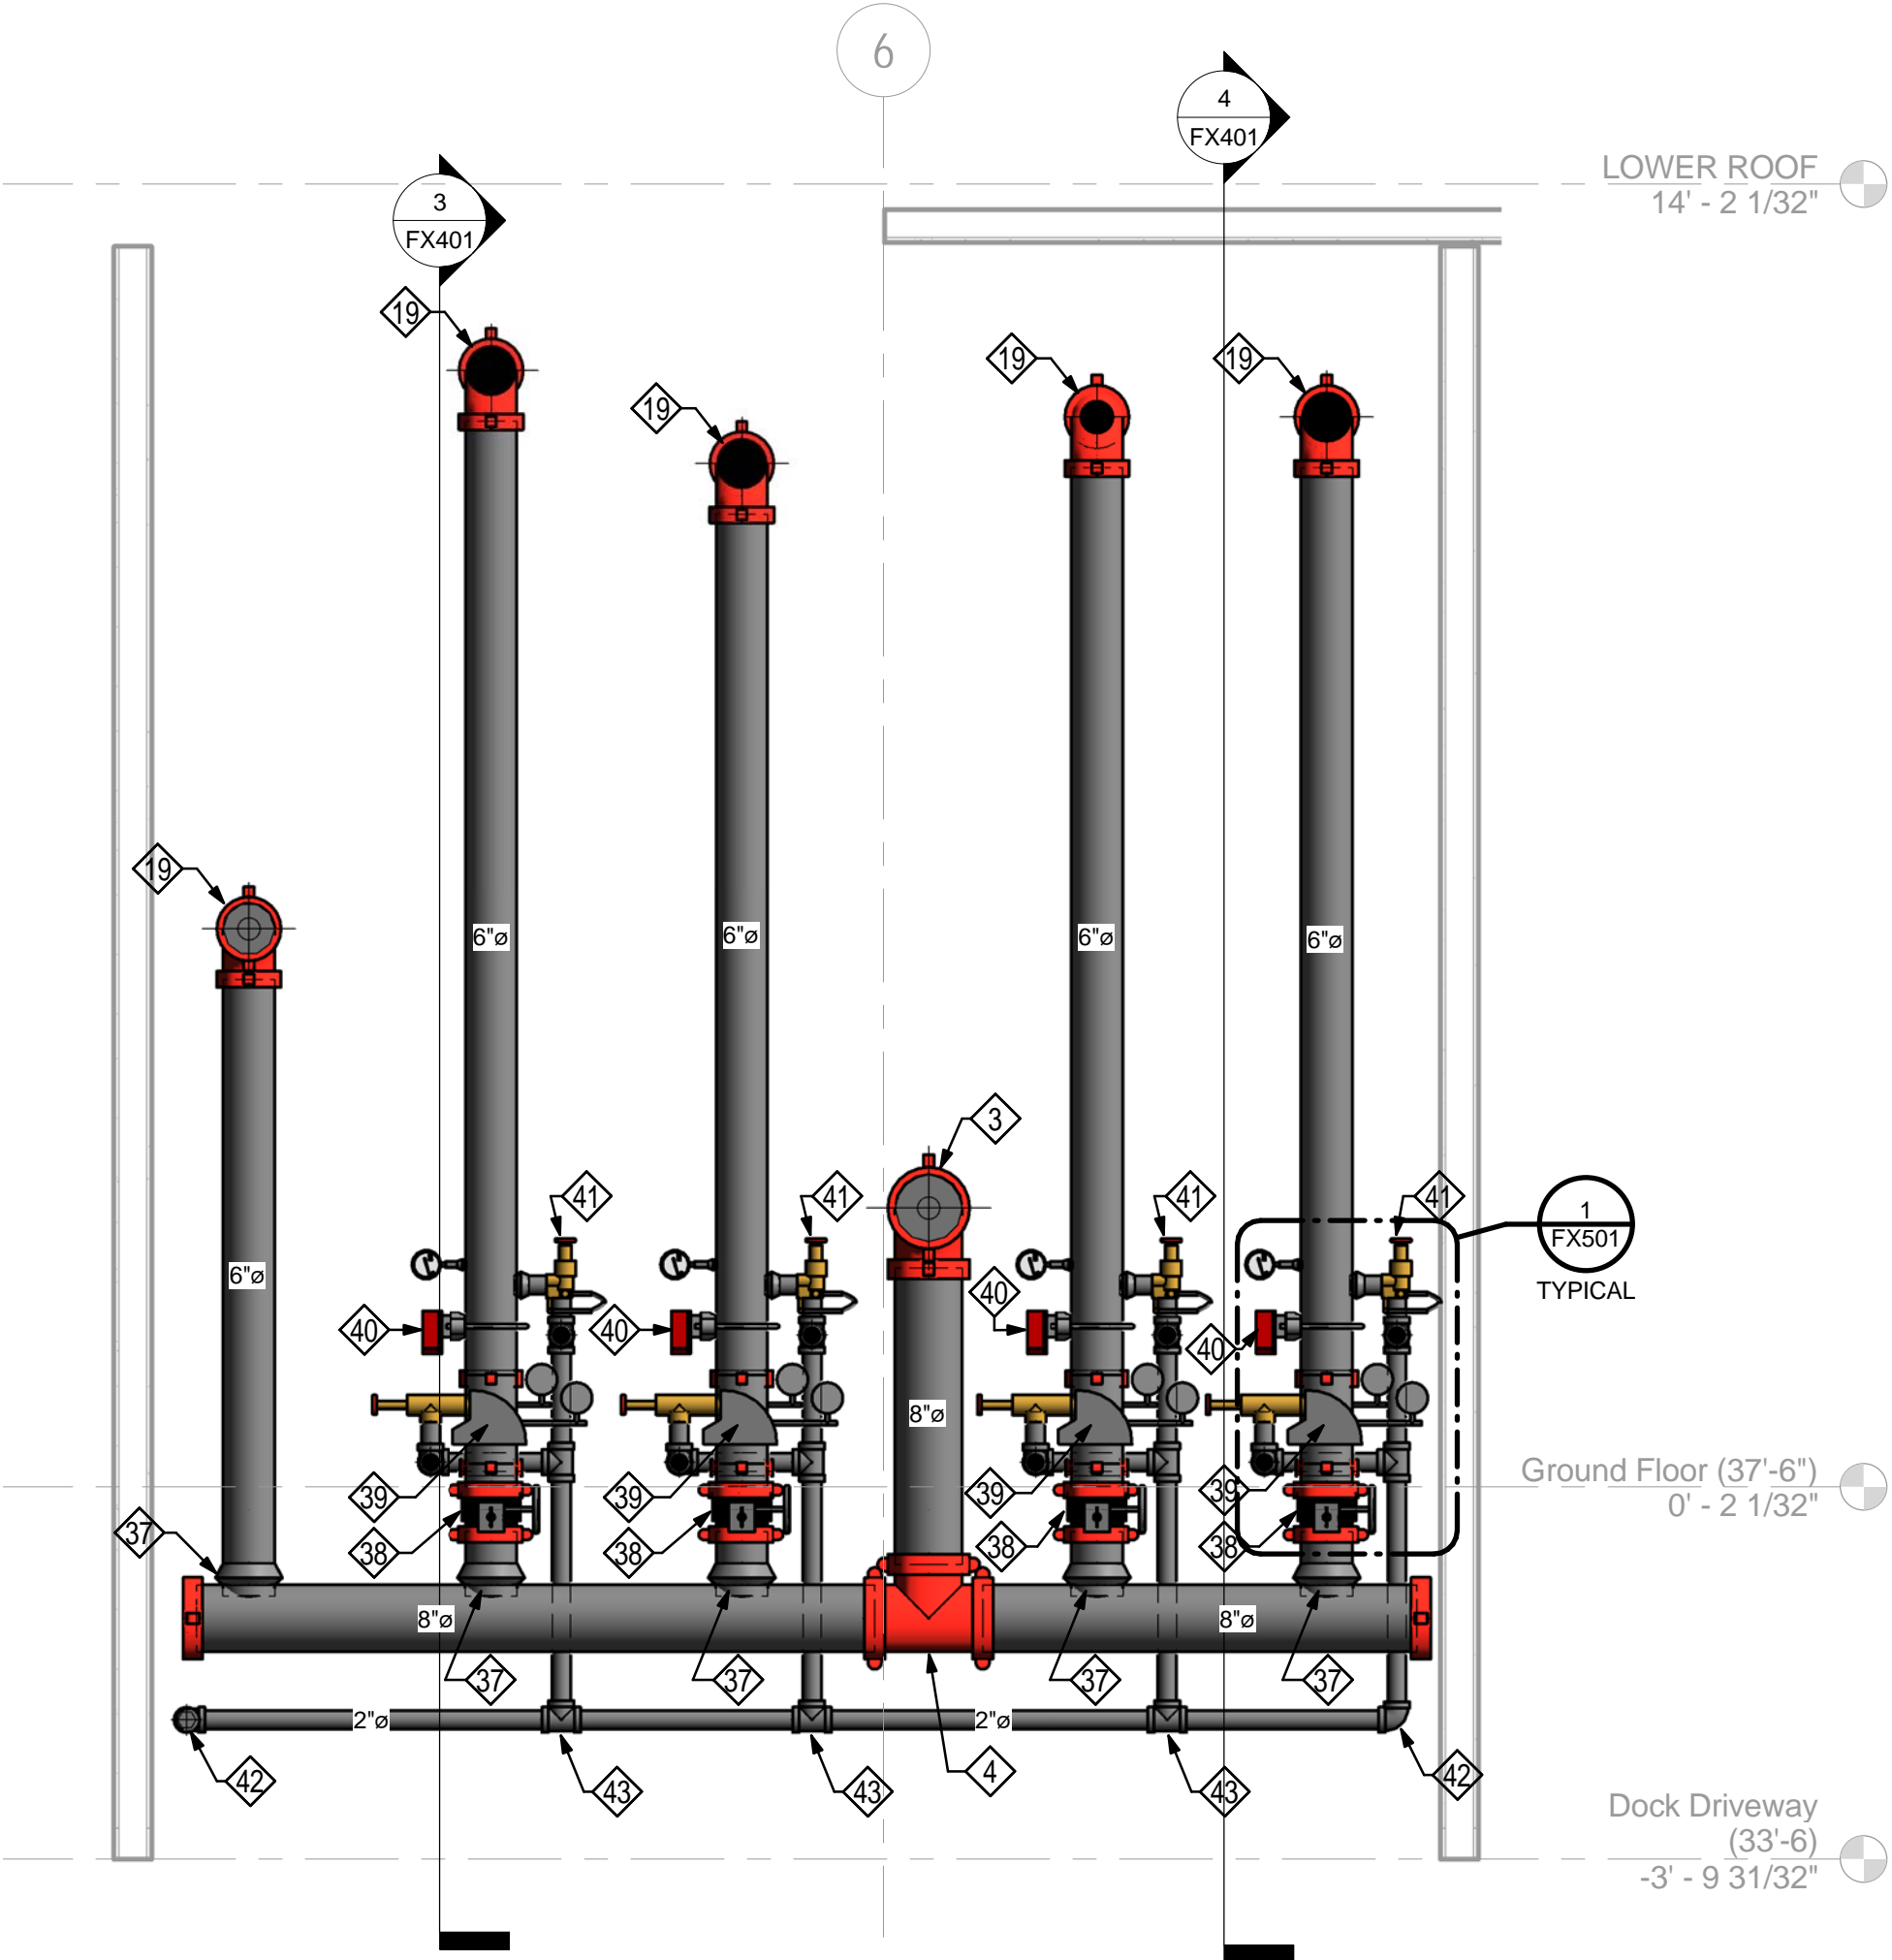


PUMP ROOM ELEVATION - RISER MANIFOLD

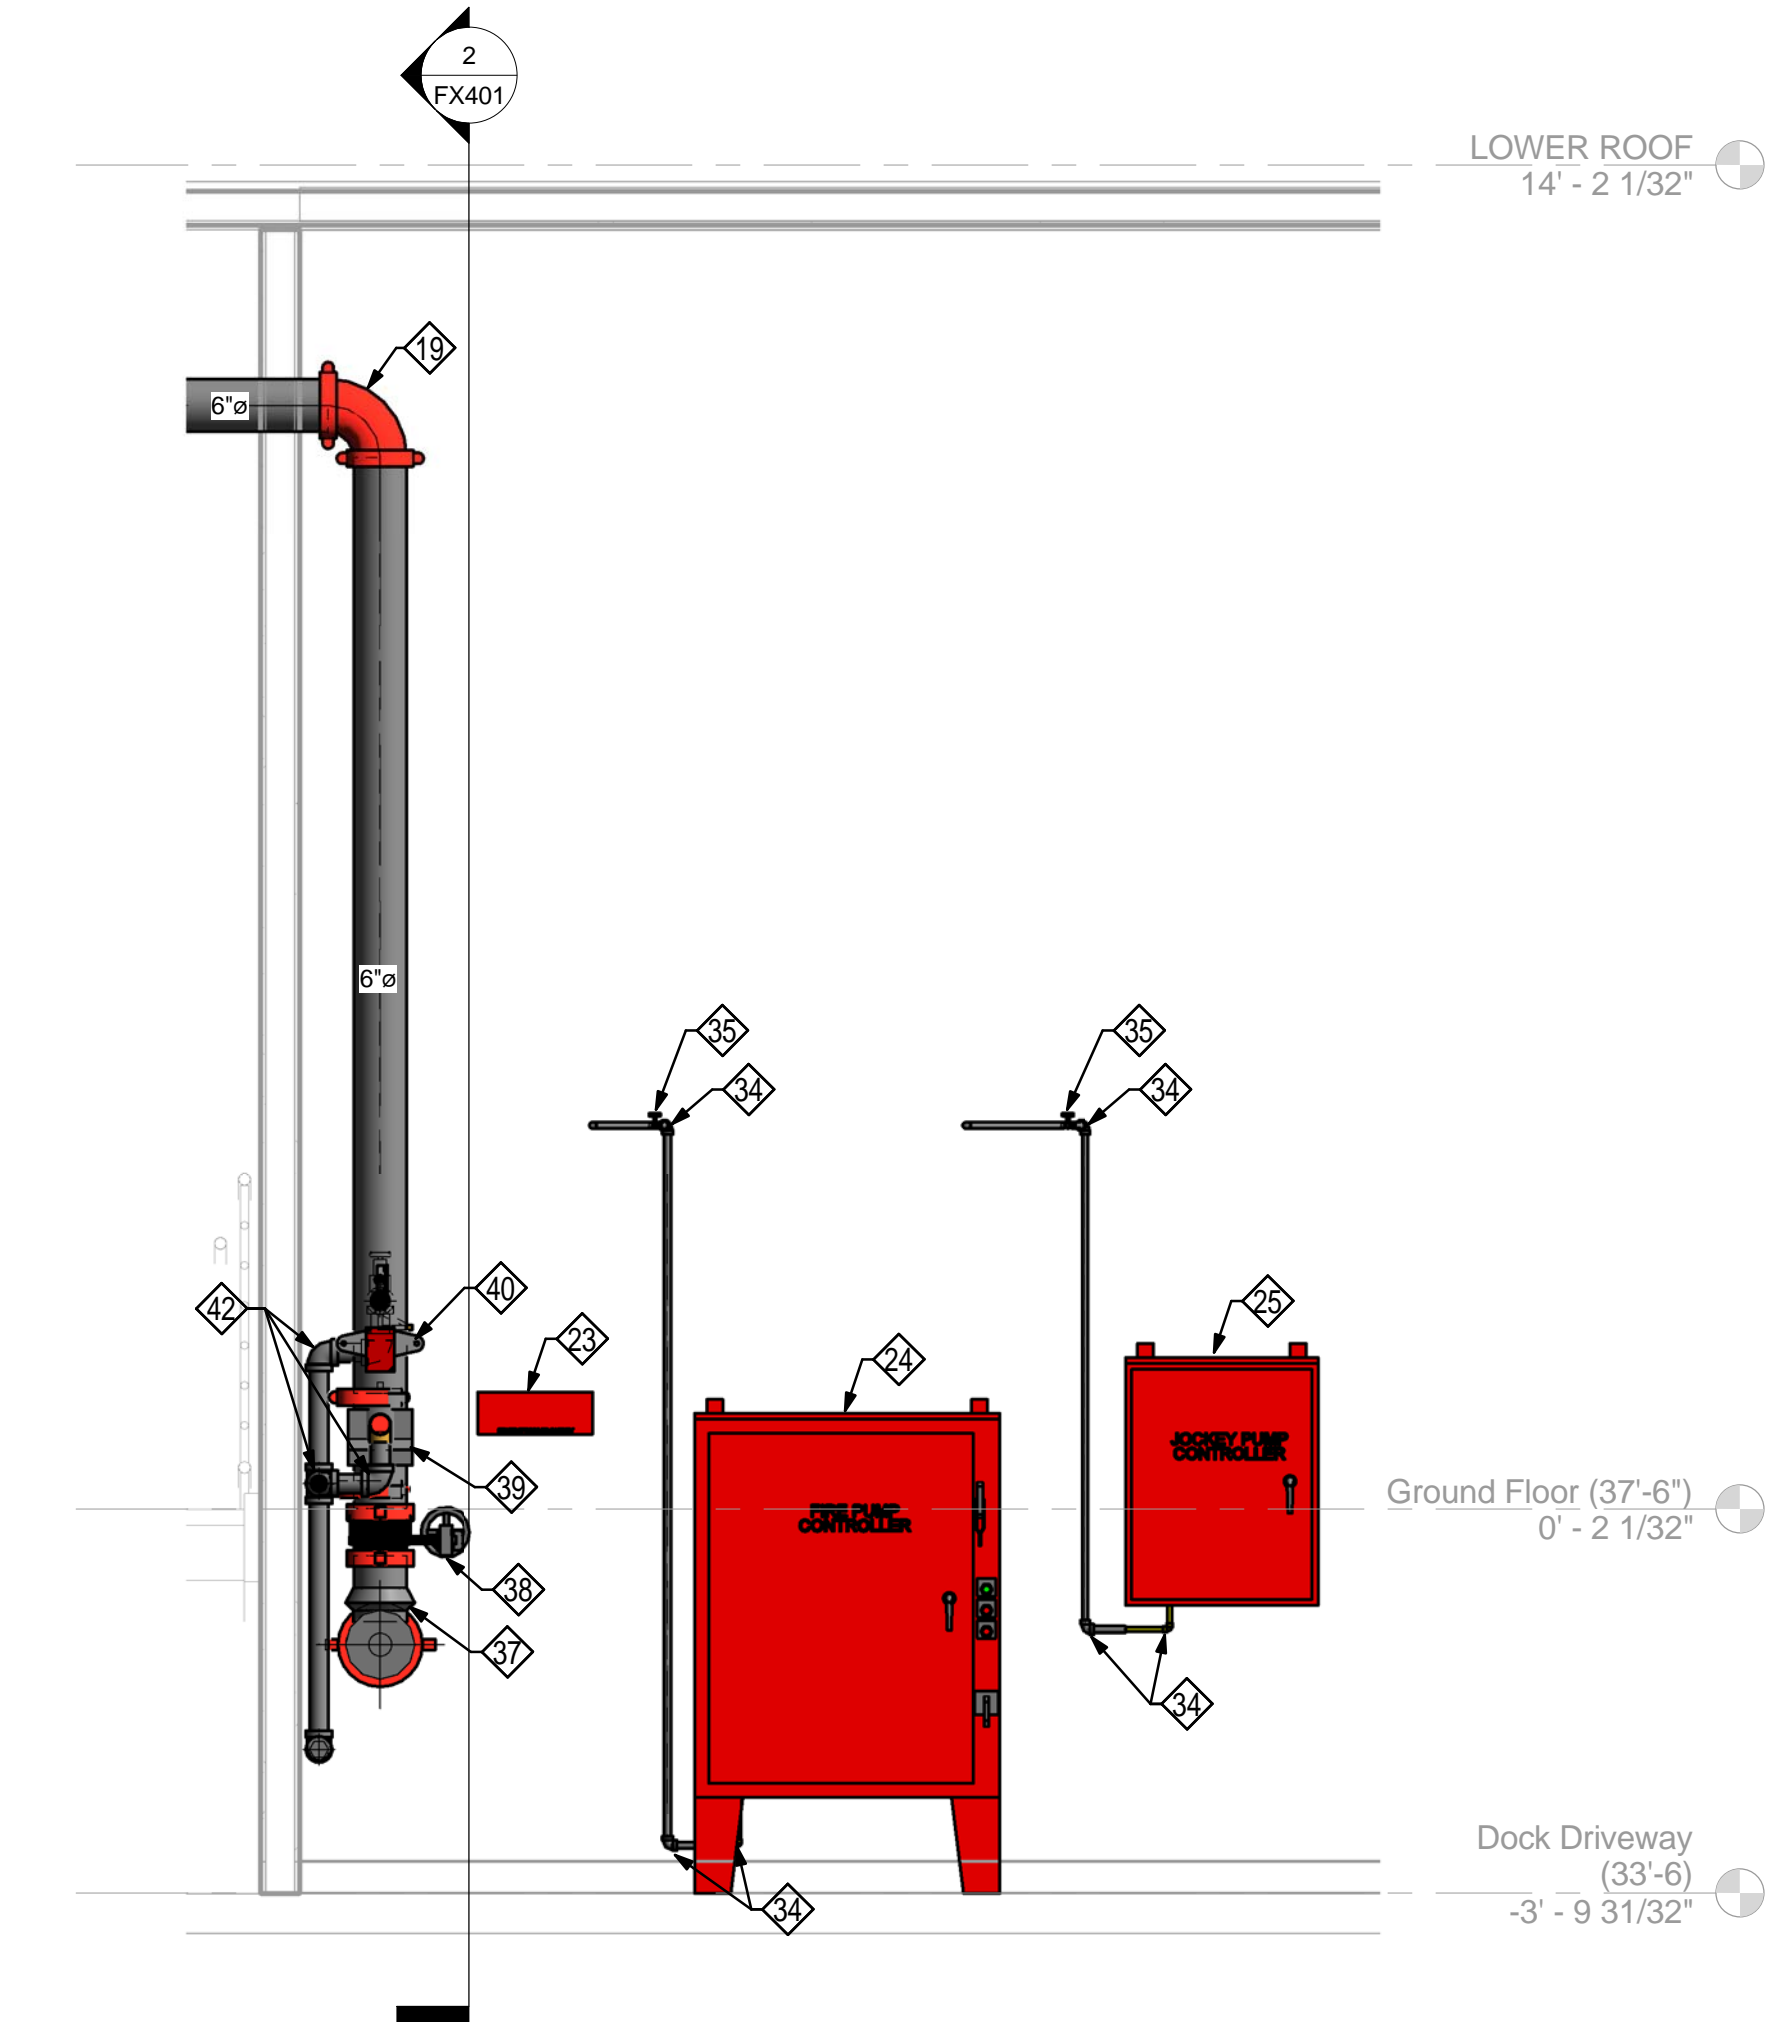

FIRE PUMP ROOM SECTION

1/2" = 1'-0"


FX401

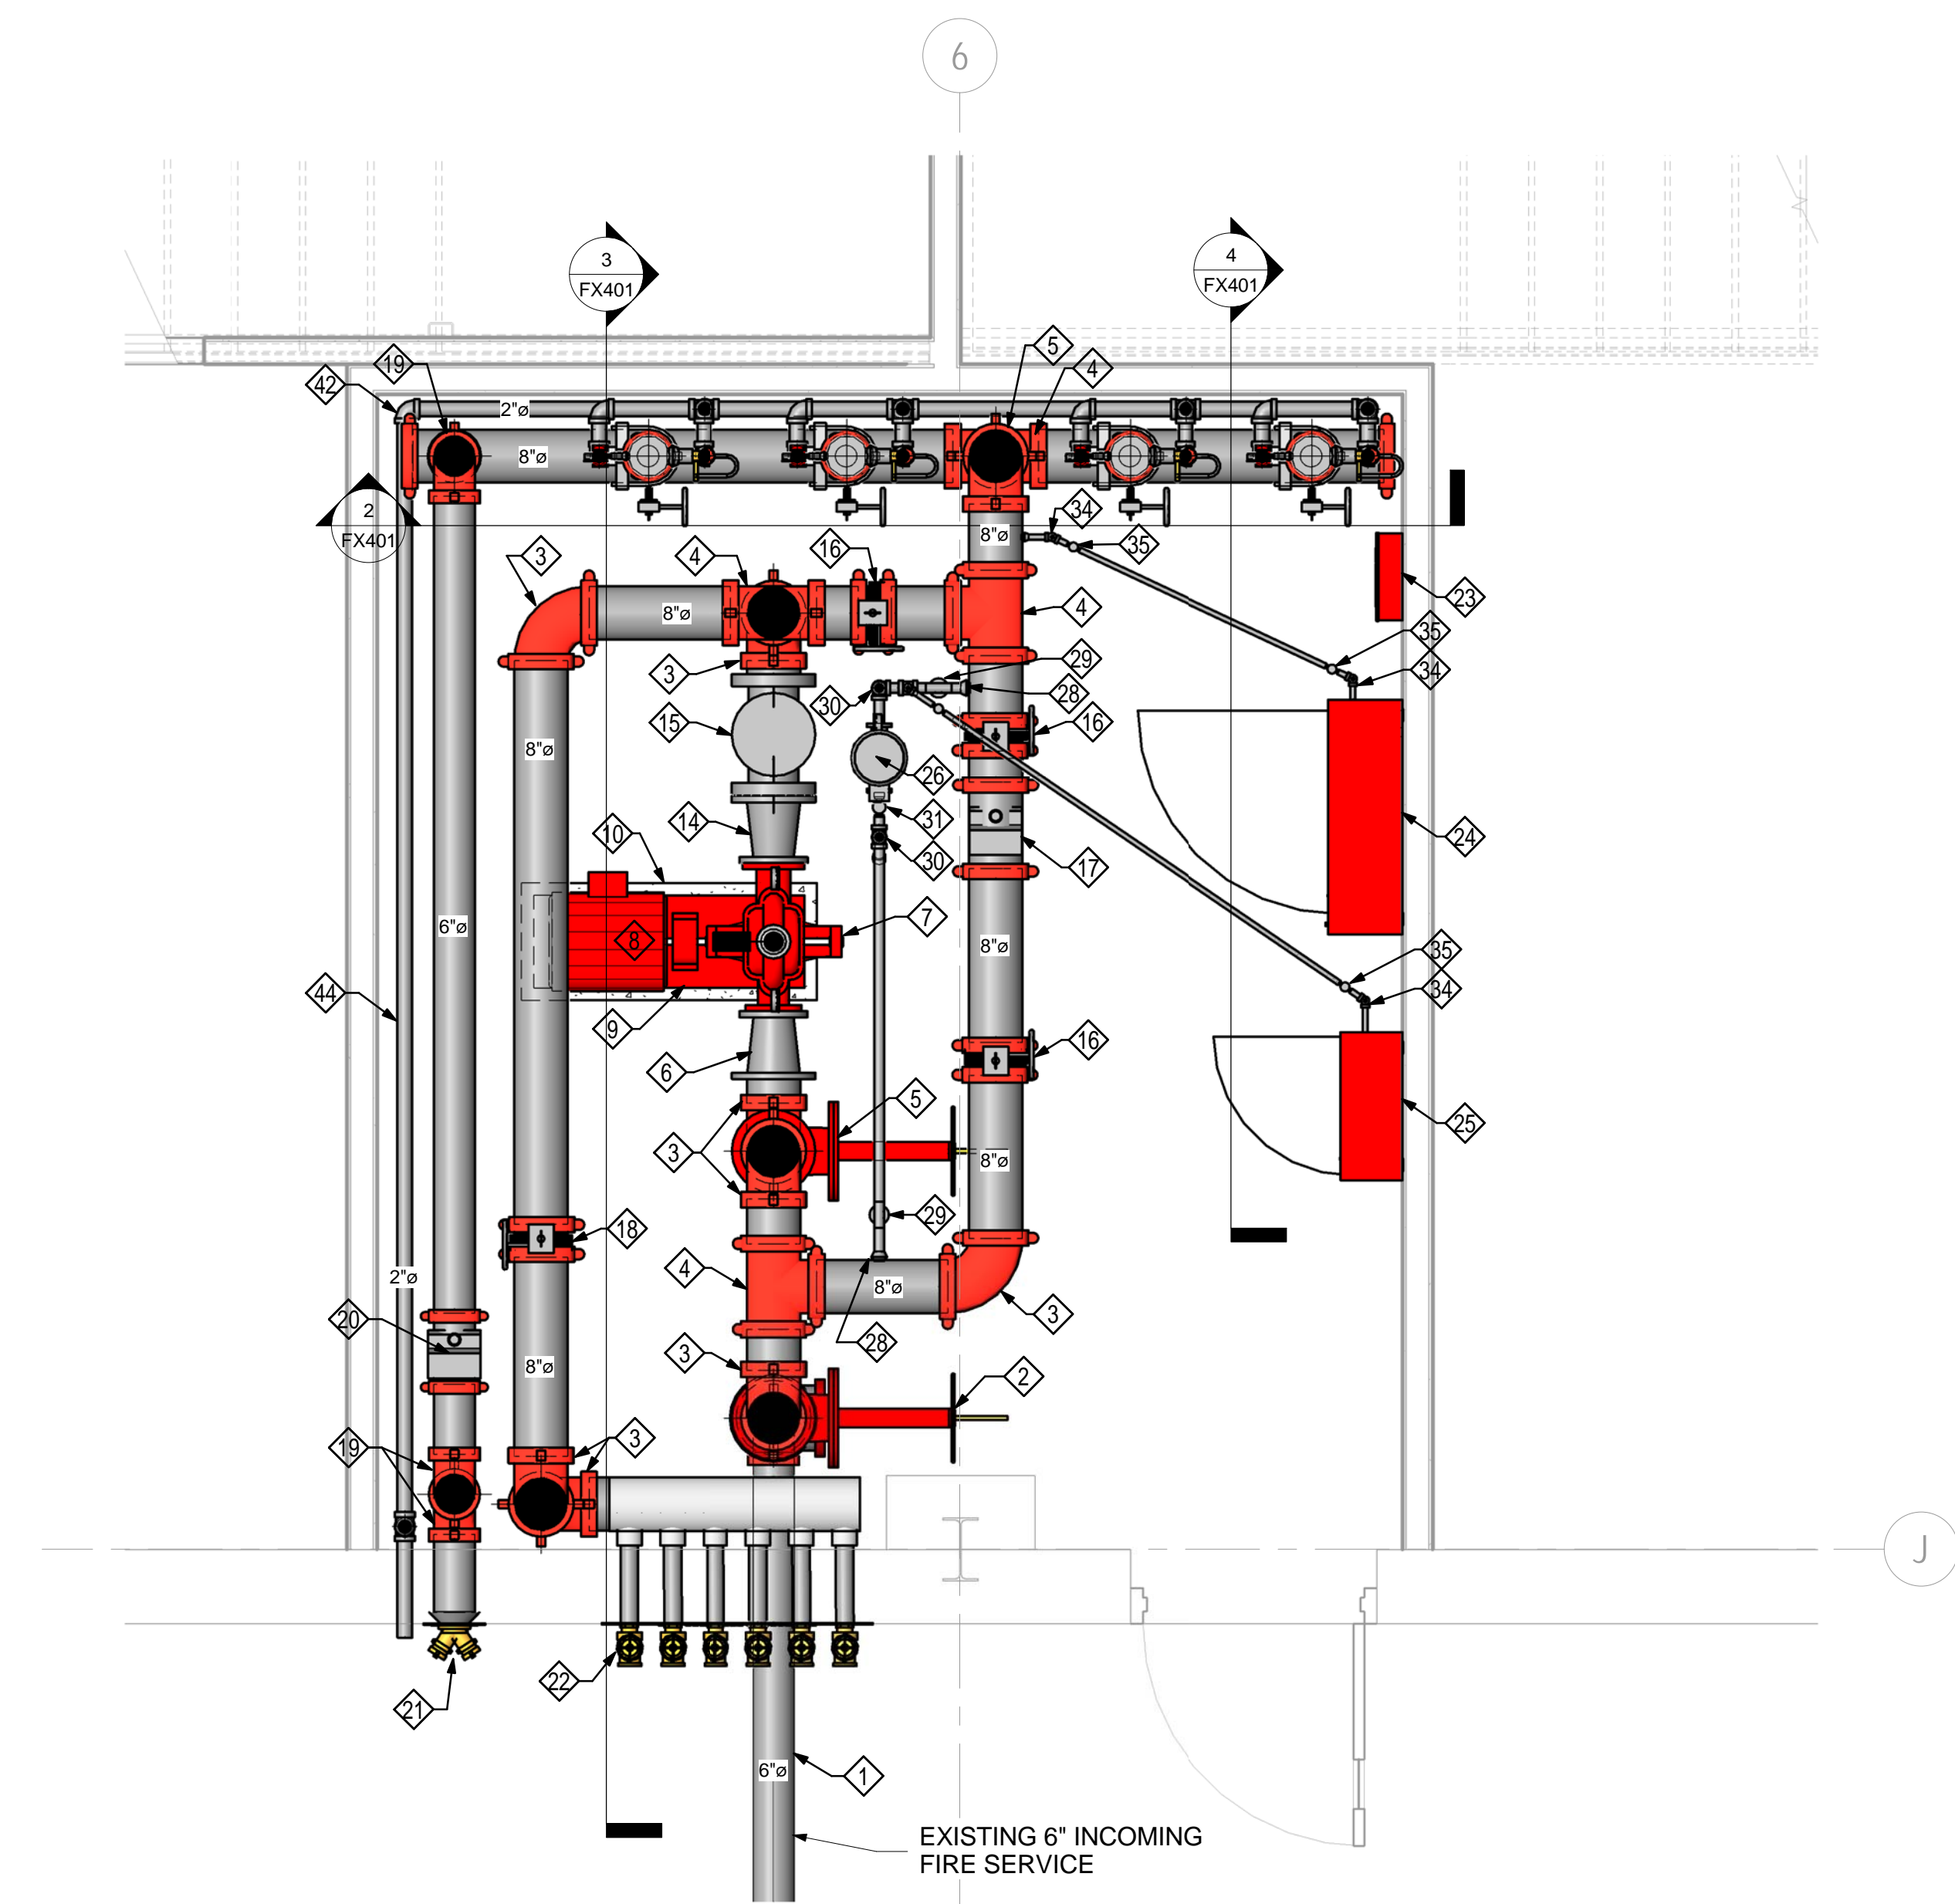

FIRE PUMP ROOM PLAN

1/2" = 1'-0"

FX401

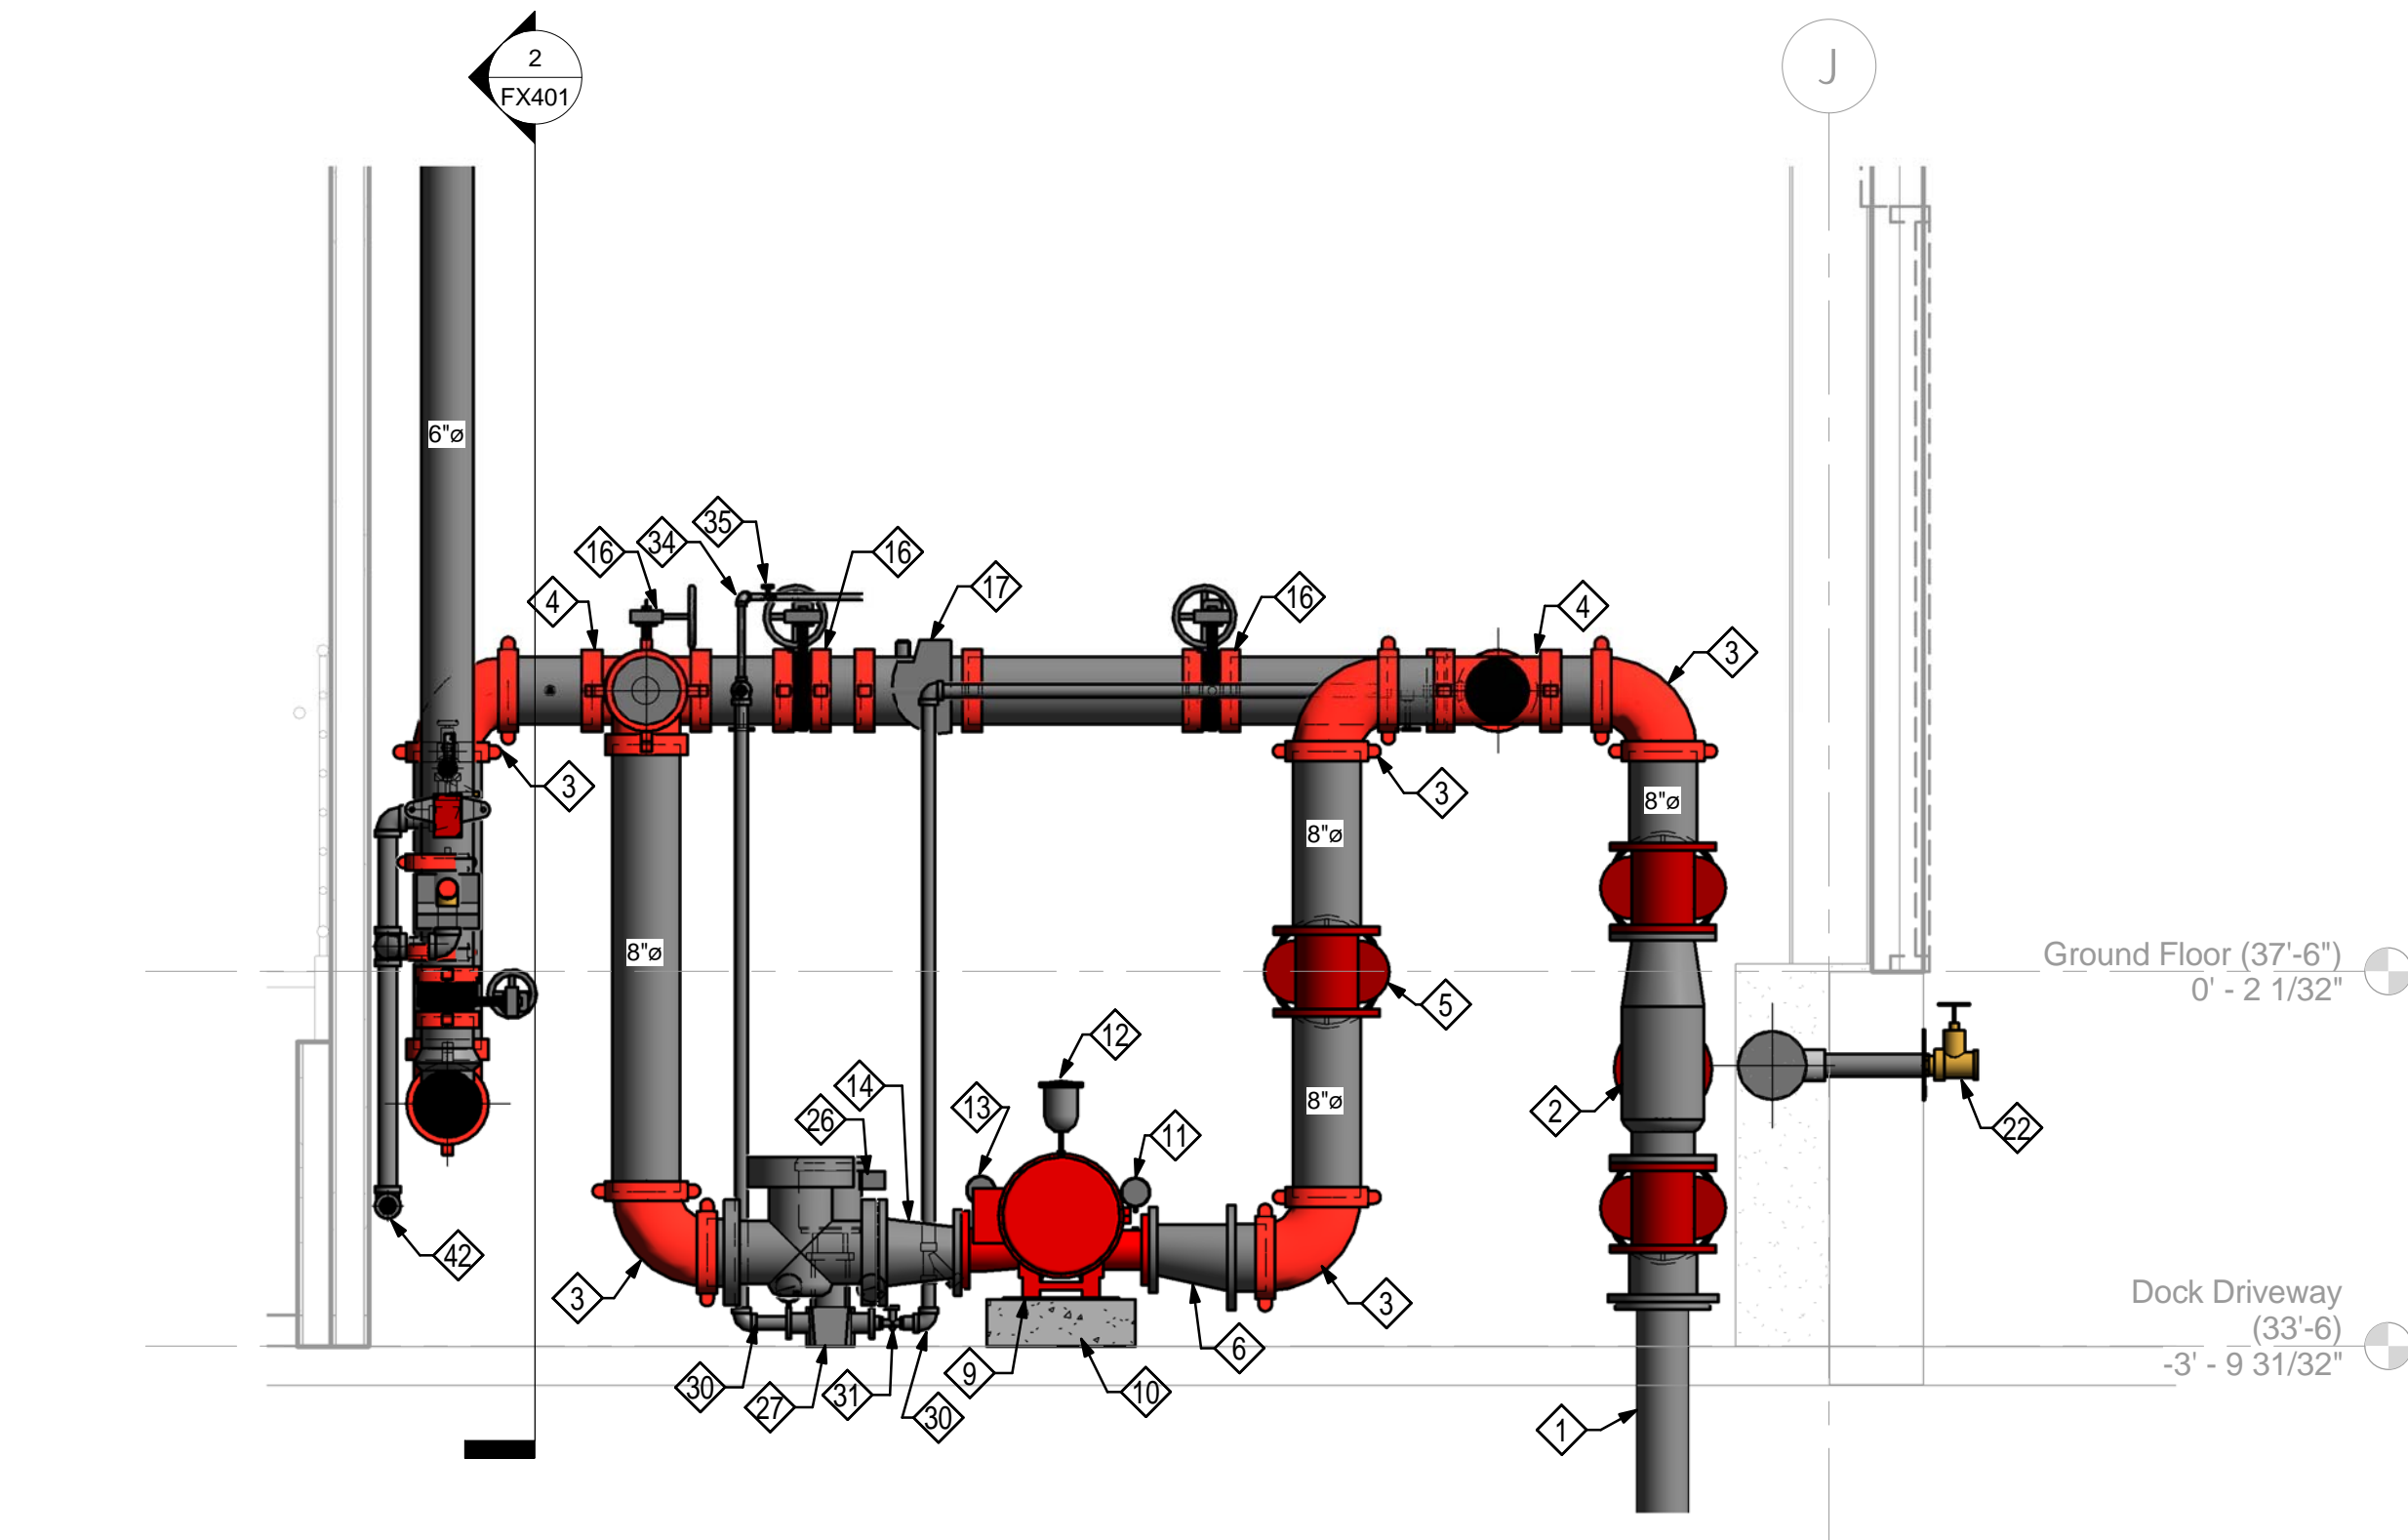

FIRE PUMP ROOM SECTION

1/2" = 1'-0"

FX401

Additions:	Date
Revisions:	Date
SCHEMATIC DESIGN (30%) SUBMISSION	03/25/15
DESIGN DEVELOPMENT (60%) SUBMISSION	09/11/15
CONSTRUCTION DOCUMENTS (90% SUBMISSION)	11/23/15
BID DOCUMENTS SUBMISSION	03/17/16

ARCHITECT / ENGINEERS / CONSULTANTS:	
OKKS Studios, Inc. 2 Wisconsin Circle / Suite 820 Chevy Chase, MD 20815-7003 Tel: (301) 718-0080 Fax: (301) 718-9520 www.okksstudios.com	Woods Peacock Engineering Consultants 5250 Cherokee Avenue, Suite 420 Alexandria, VA 22312-2052 Tel: (703) 658-4400 Fax: (703) 658-4404
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Henry Adams Consulting Engineers, LLC 600 Baltimore Avenue, 4th Floor Baltimore, MD 21204 Tel: (410) 296-6500 Fax: (410) 296-6501	



Approved:	Approved: Chief, Facilities and Engineering
	Approved: Associate Chief for Maintenance And Operations, Perry Point
	Approved: Engineering Projects Supervisor
	Approved: Infection Control Officer

Approved: Chief, Facilities and Engineering	Approved: Associate Chief for Maintenance And Operations, Perry Point
Approved: Engineering Projects Supervisor	Approved: Infection Control Officer

Drawing Title	FIRE PUMP PLAN
Approved: Associate Director for Operations	Approved: Director, Medical Center

FULLY SPRINKLERED

WAREHOUSE RENOVATION & EXPANSION

Project Title	WAREHOUSE RENOVATION & EXPANSION
Scale	1/2" = 1'-0"
Building Number	360
Checked	CKC
Drawn	ACJ
Location	PERRY POINT, MD

03/17/16


VA Project Number
512-530

Drawing Number
FX401


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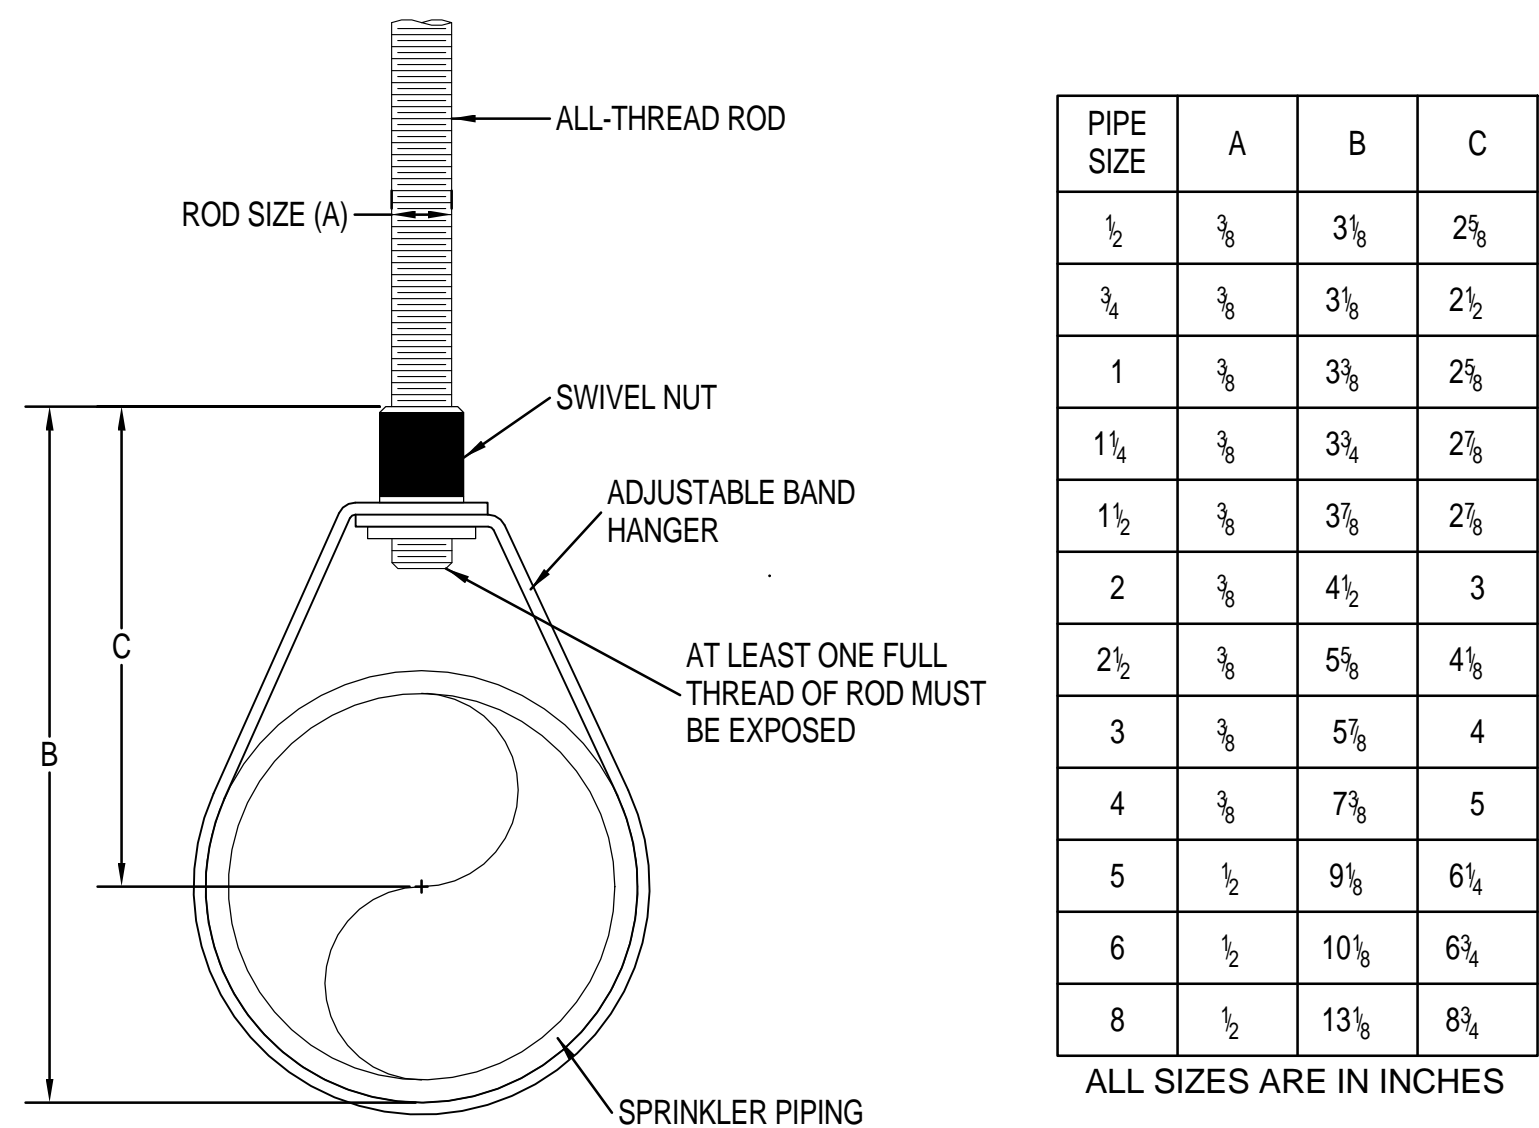
THREE INCHES - ONE FOOT (1' - 1'-0")
ONE AND ONE HALF INCHES - ONE FOOT (1 1/2' - 1'-0")
ONE INCH - ONE FOOT (1' - 1'-0")
THREE QUARTERS INCH - ONE FOOT (3/4' - 1'-0")
ONE HALF INCH - ONE FOOT (1/2' - 1'-0")
THREE EIGHTHS INCH - ONE FOOT (3/8' - 1'-0")
ONE QUARTER INCH - ONE FOOT (1/4' - 1'-0")
ONE EIGHTH INCH - ONE FOOT (1/8' - 1'-0")




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FX501 NOT TO SCALE

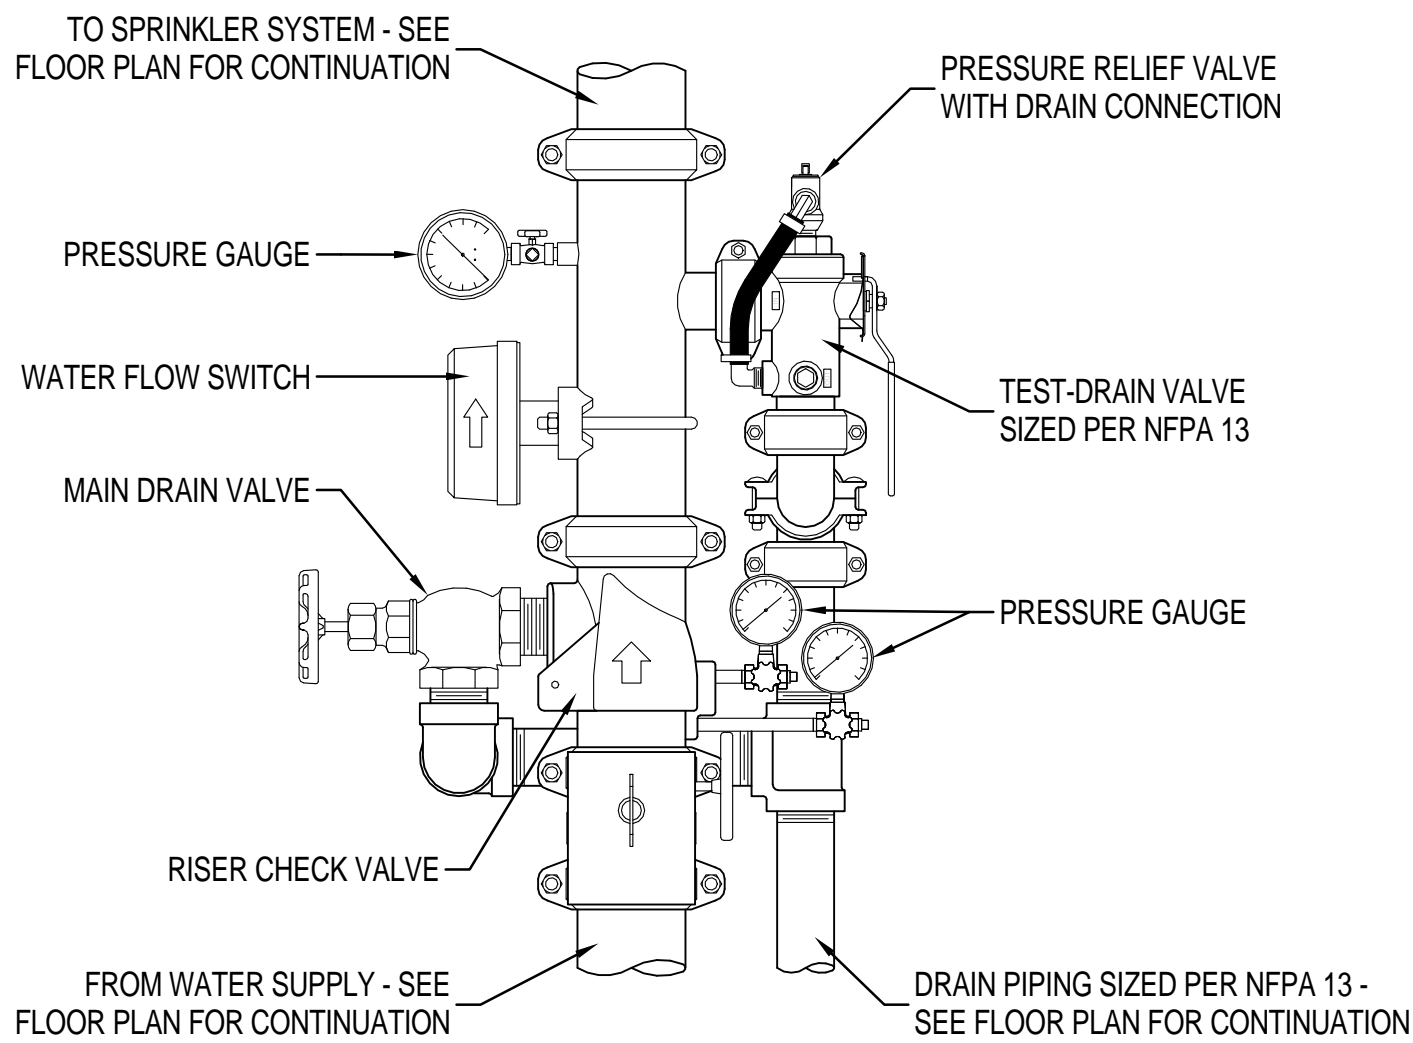


2 INSTALLATION OF STEEL C-CLAMP
FX501 NOT TO SCALE

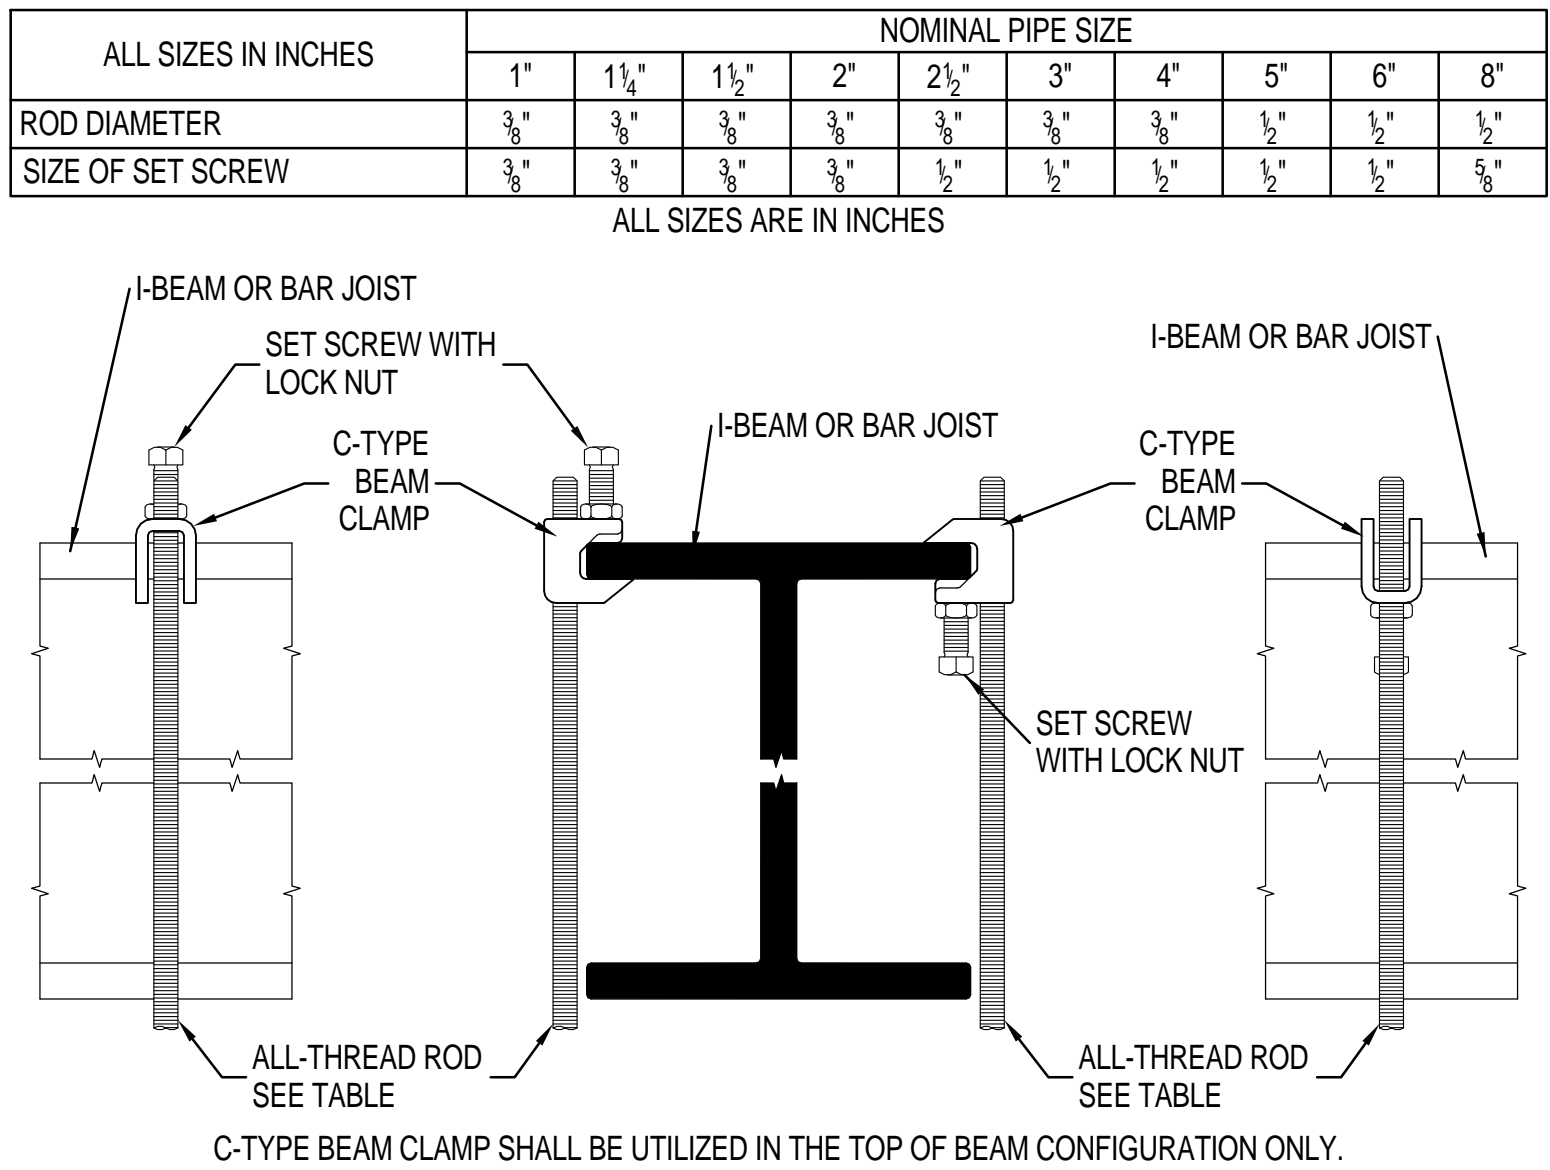


3 INSTALLATION OF ADJUSTABLE BAND HANGER
FX501 NOT TO SCALE

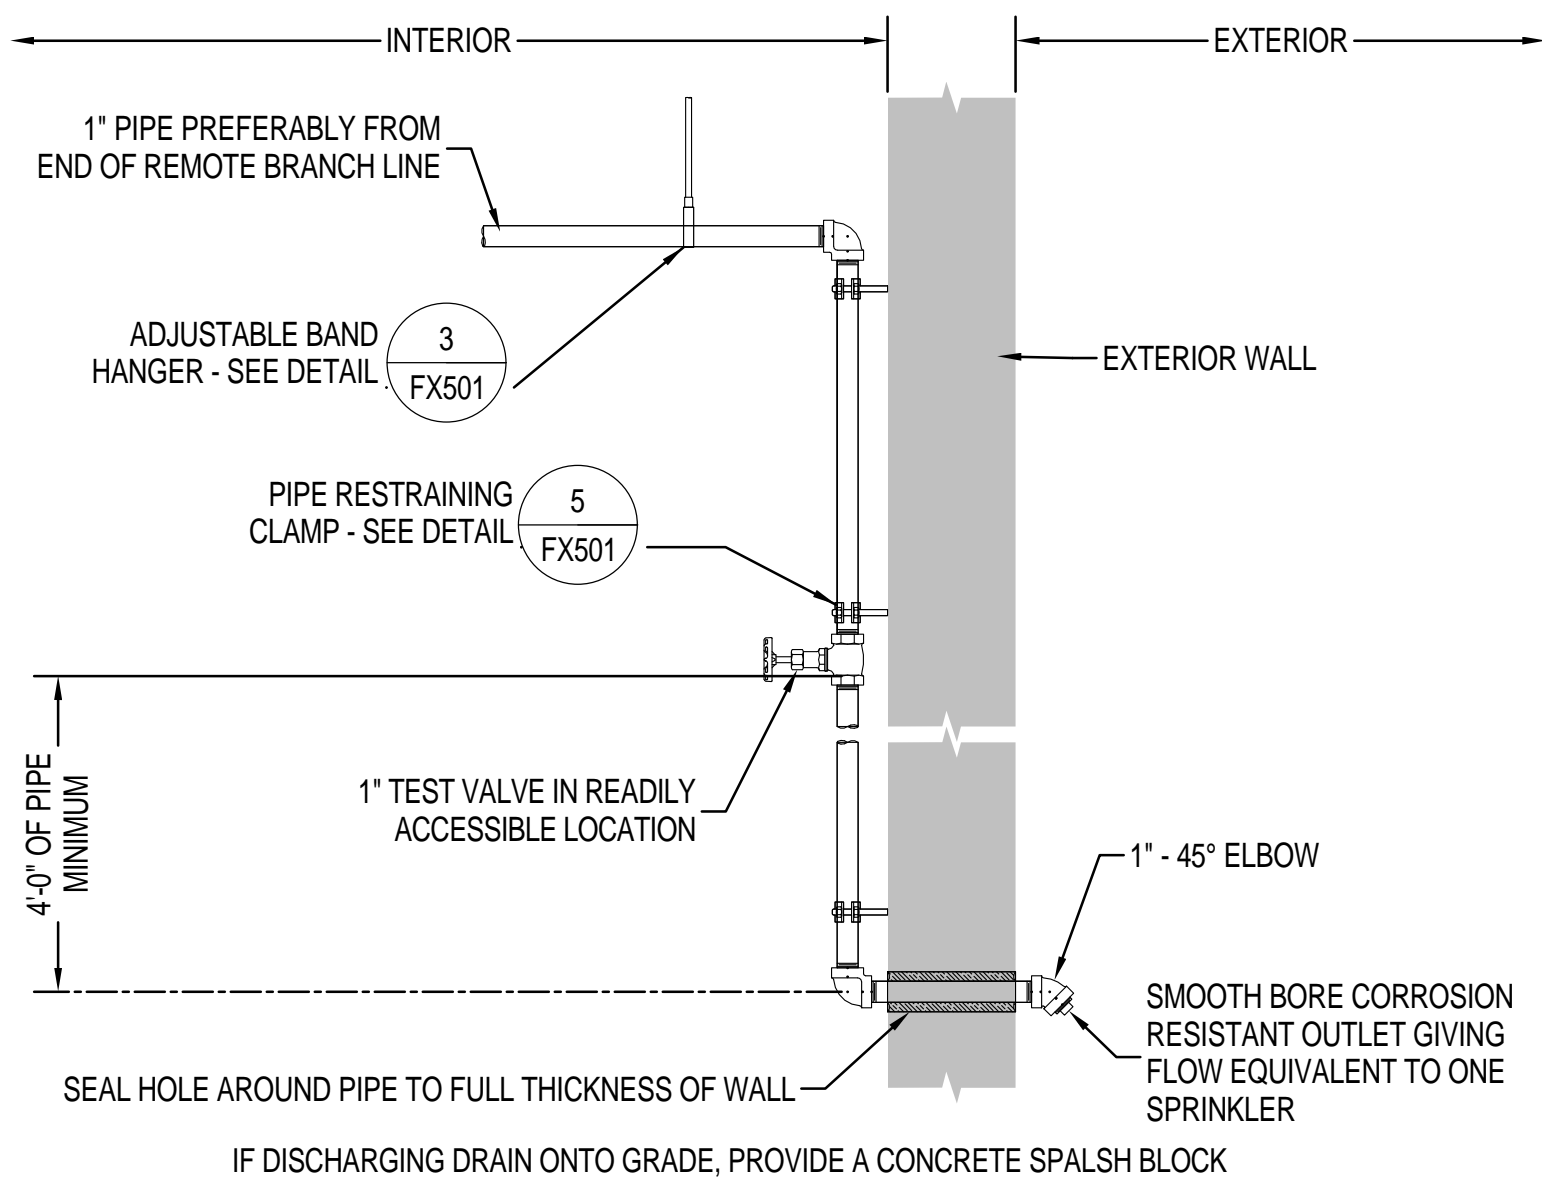


4 INSPECTOR'S TEST CONNECTION
FX501 NOT TO SCALE

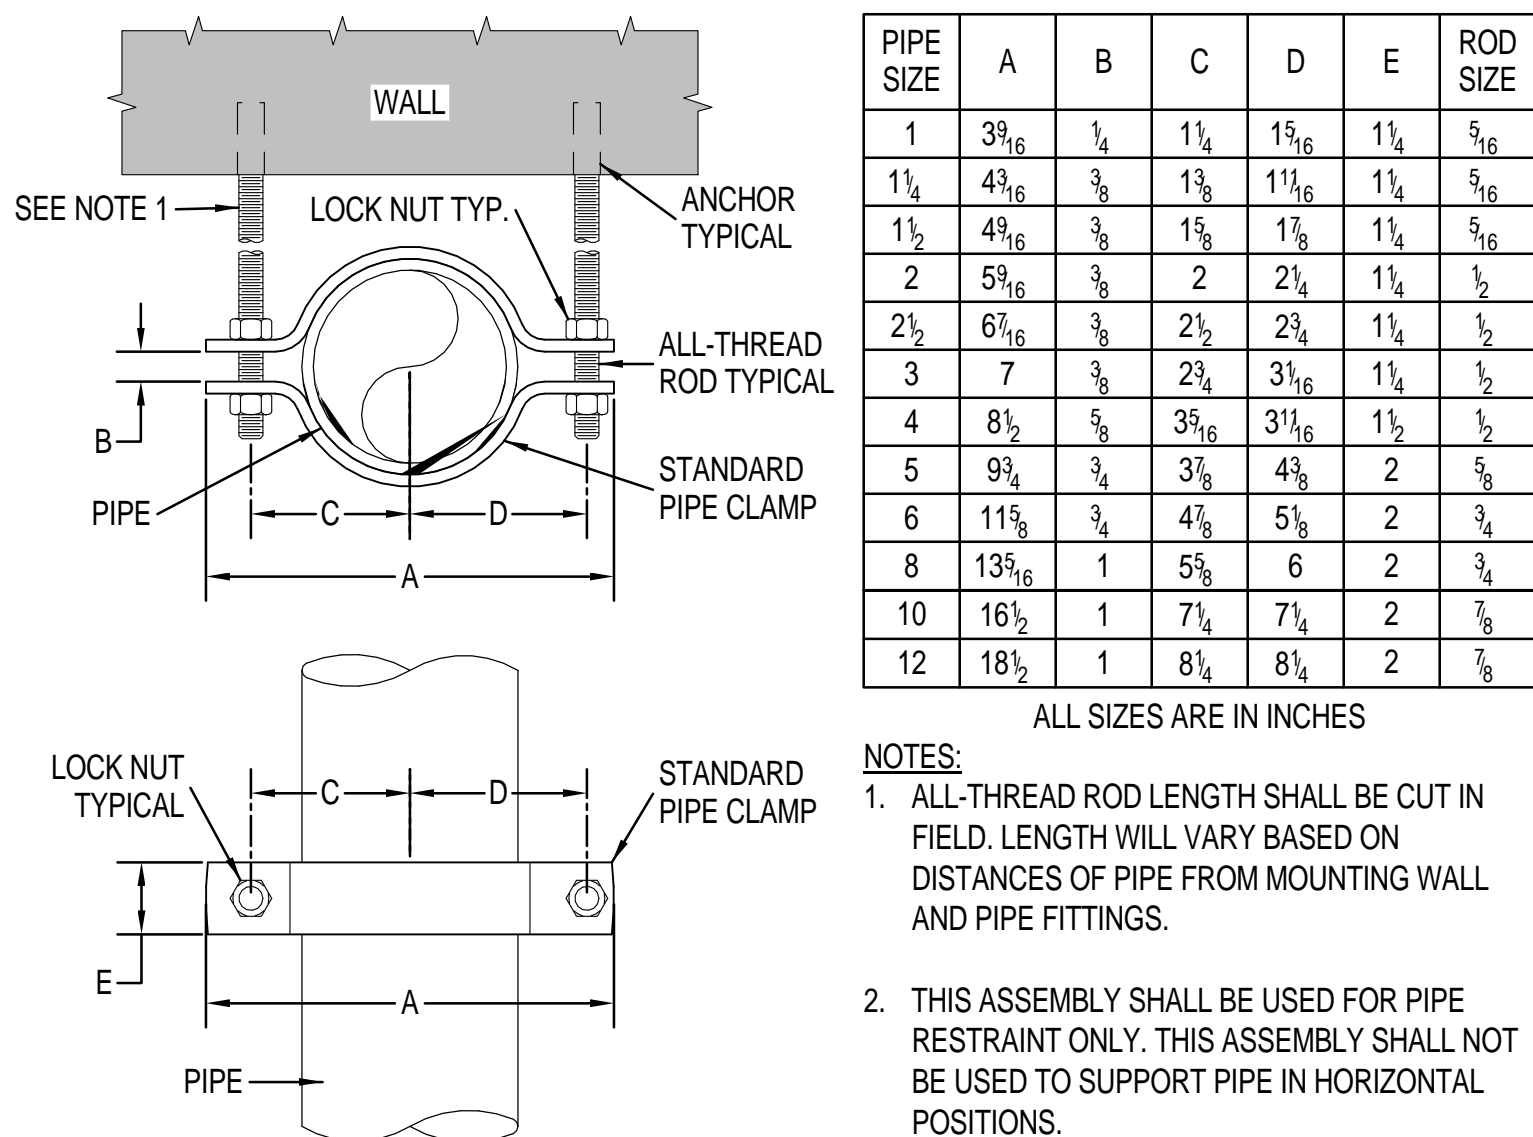


5 PIPE RESTRAINING CLAMP ASSEMBLY
FX501 NOT TO SCALE

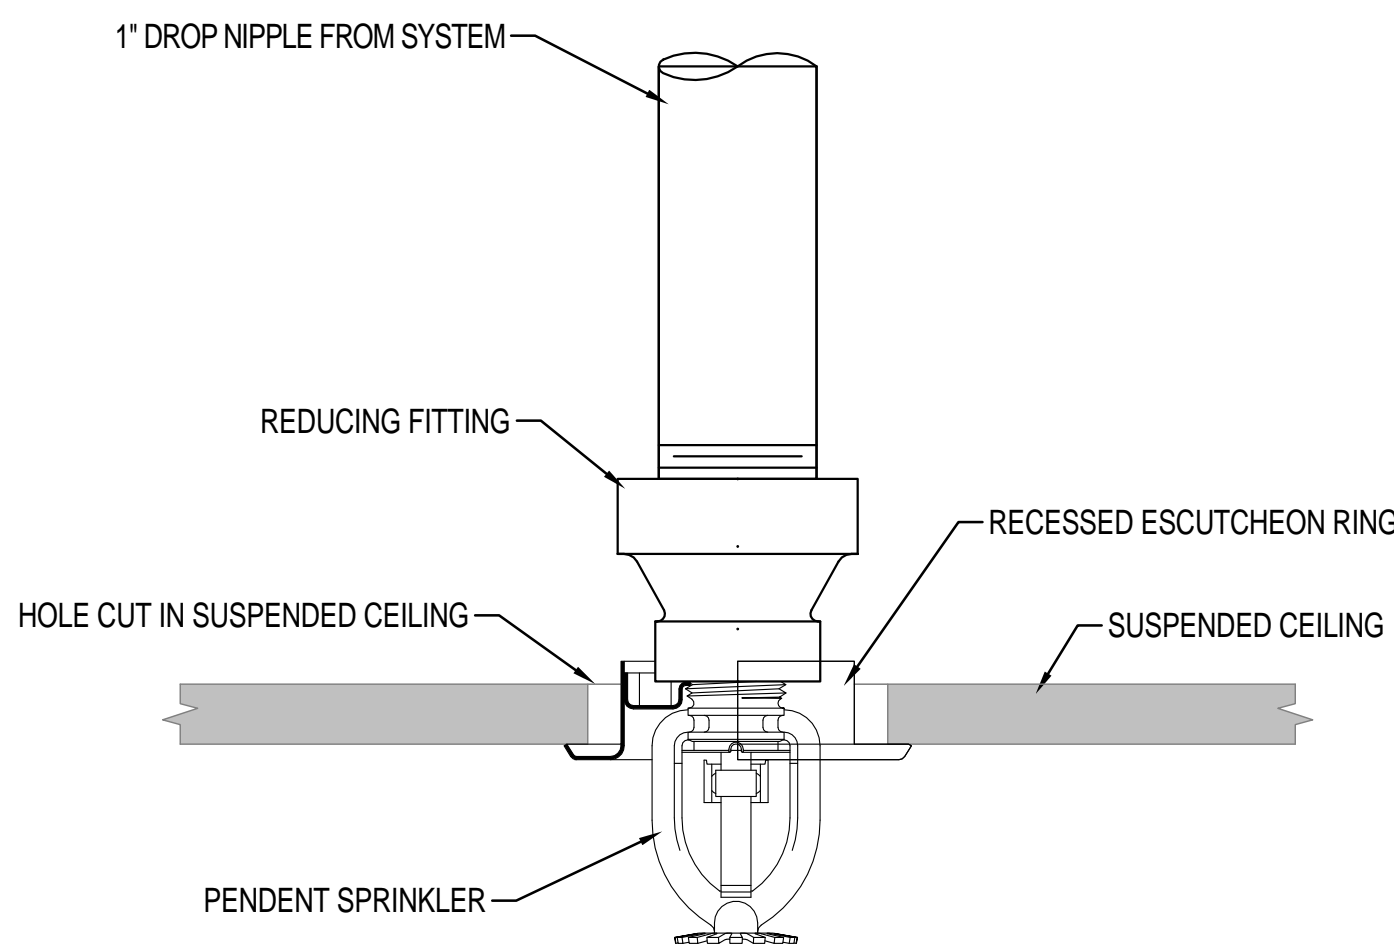


6 RECESSED PENDENT SPRINKLER IN CEILING
FX501 NOT TO SCALE

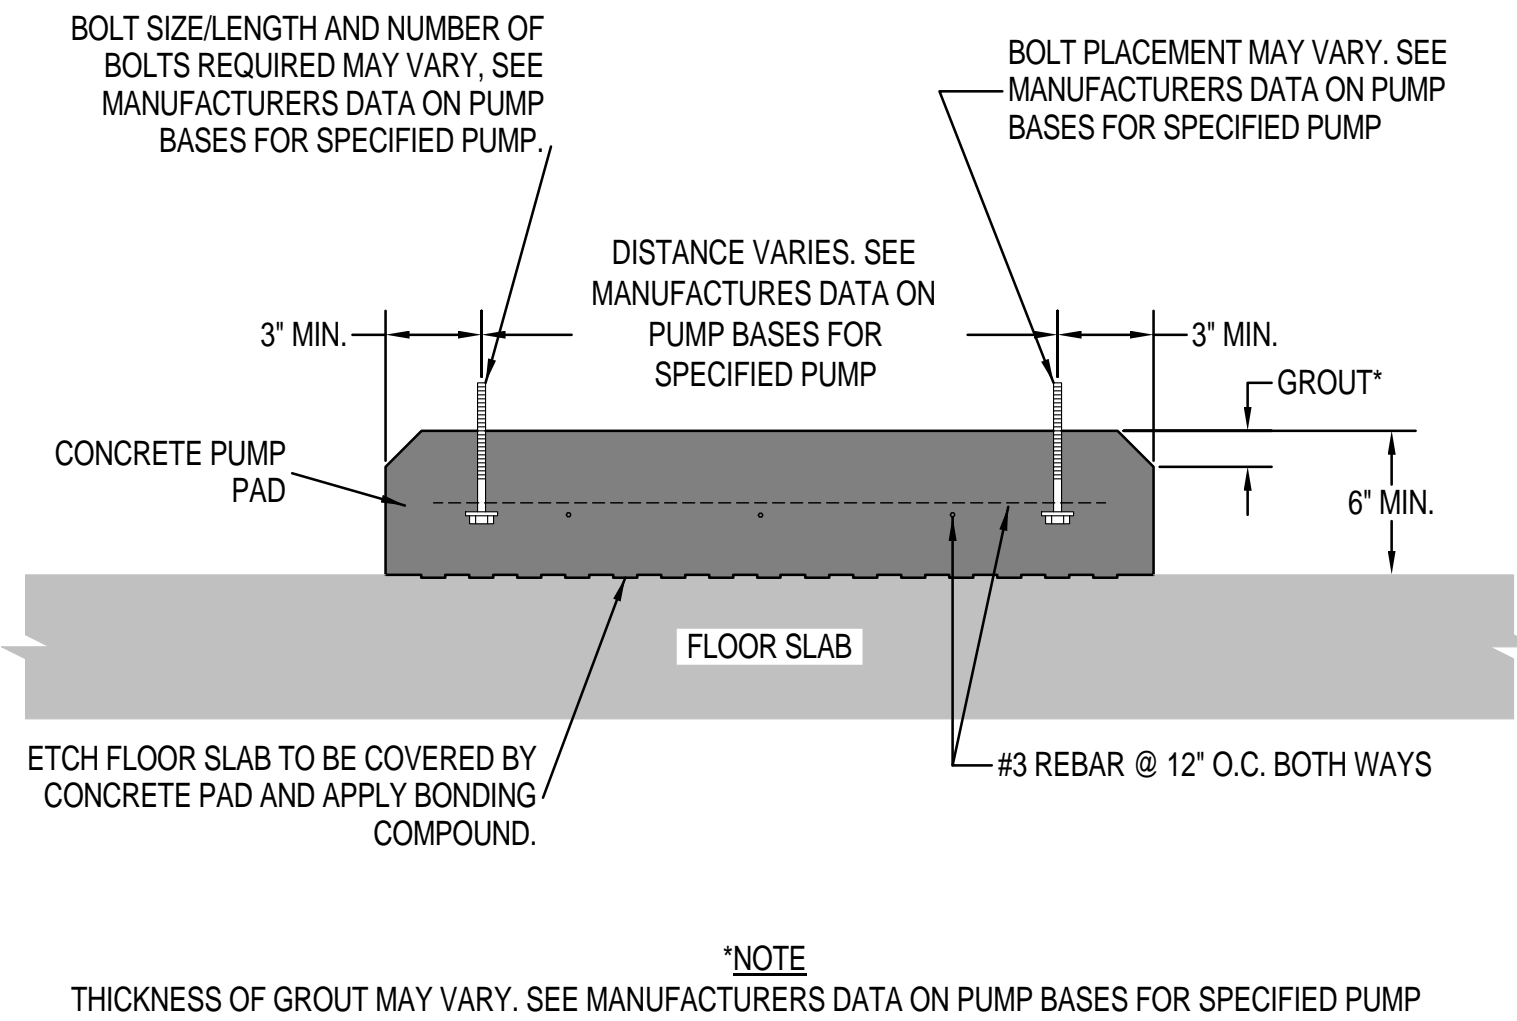

7 CONCRETE PUMP PAD
FX501 NOT TO SCALE

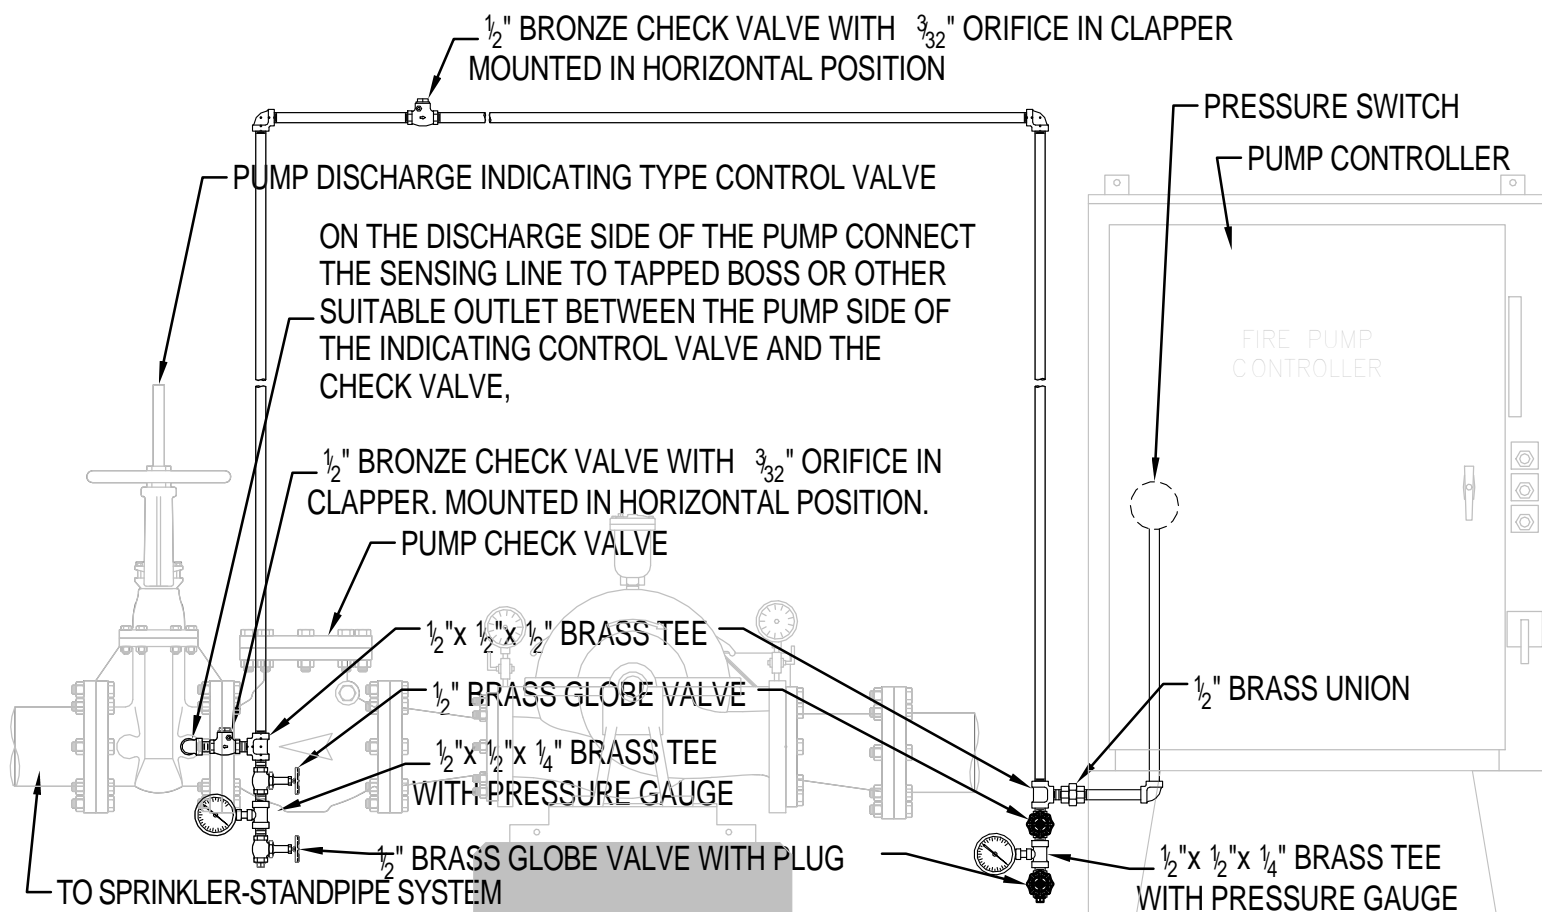

8 PUMP CONTROLLER SENSING LINE CONNECTIONS
FX501 NOT TO SCALE

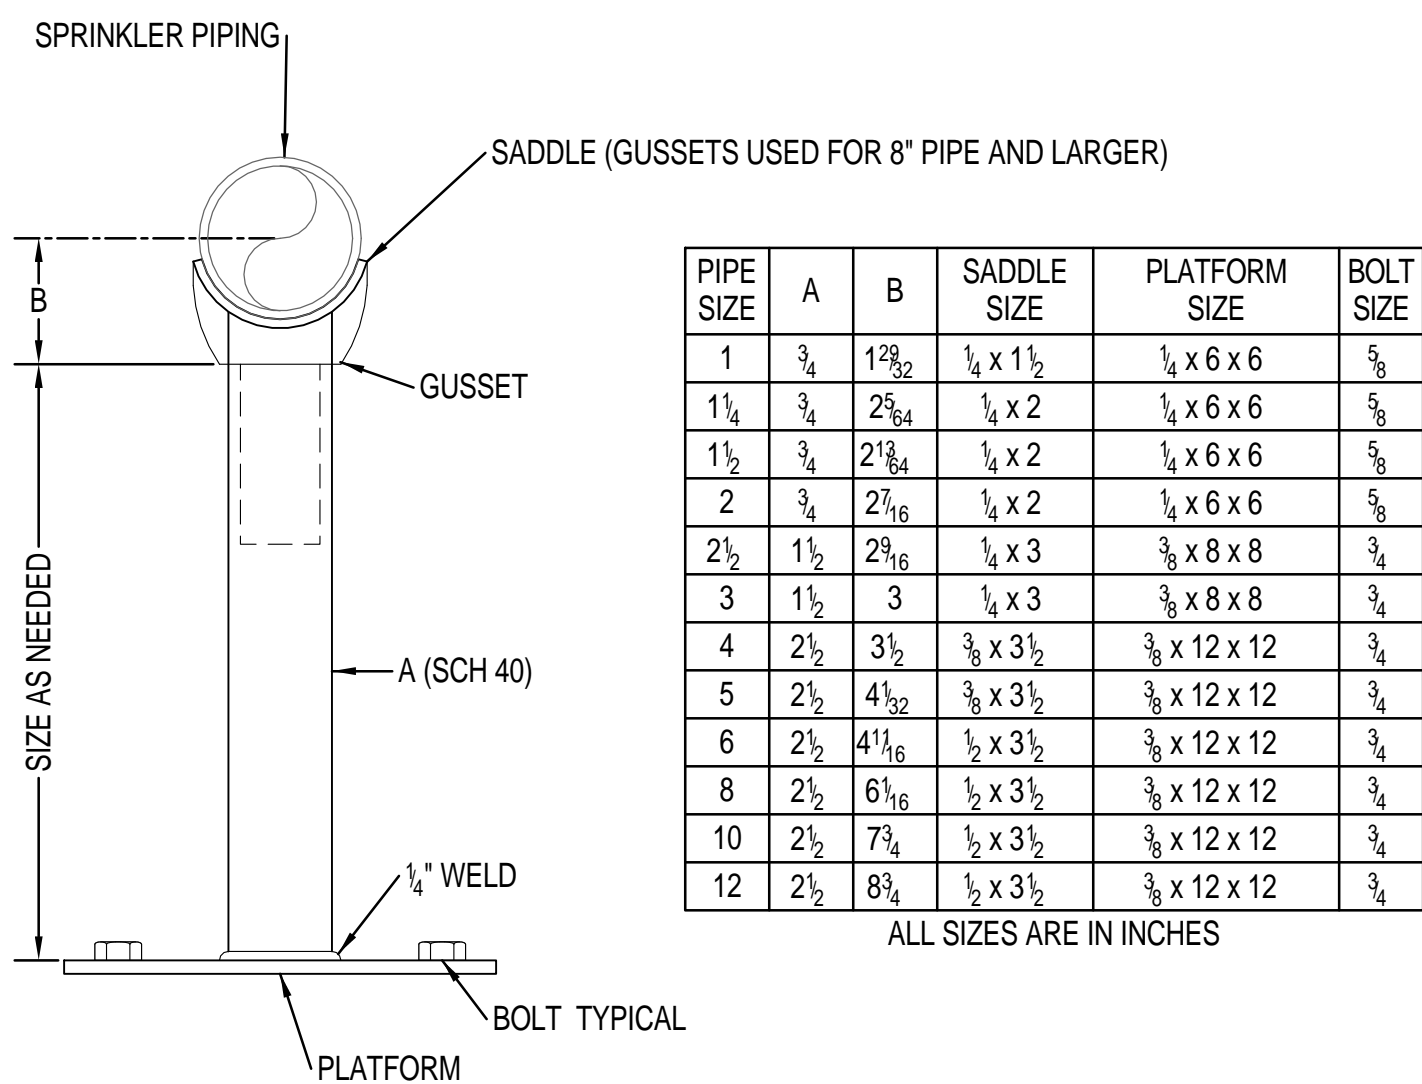

9 PIPE SADDLE SUPPORT STAND
FX501 NOT TO SCALE

Additions:	Date
Revisions:	Date
SCHEMATIC DESIGN (30%) SUBMISSION	03/25/15
DESIGN DEVELOPMENT (60%) SUBMISSION	09/11/15
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BID DOCUMENTS SUBMISSION	03/17/16

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Approved:

Approved: Chief, Facilities and Engineering
Approved: Associate Chief for Maintenance And Operations, Perry Point
Approved: Engineering Projects Supervisor
Approved: Infection Control Officer

Drawing Title
SPRINKLER DETAILS
Approved: Associate Director for Operations
Approved: Director, Medical Center

FULLY SPRINKLERED			
Project Title	Date	Scale	Building Number
WAREHOUSE RENOVATION & EXPANSION	03/17/16	NOT TO SCALE	360
Checked	Drawn	Drawing Number	
CKC	ACJ	FX501	
Location			
PERRY POINT, MD			



